


RENOVATE BASE SUPPLY, B180
LRXQ172402
MS AIR NATIONAL GUARD
172ND AIRLIFT WING
JACKSON, MS

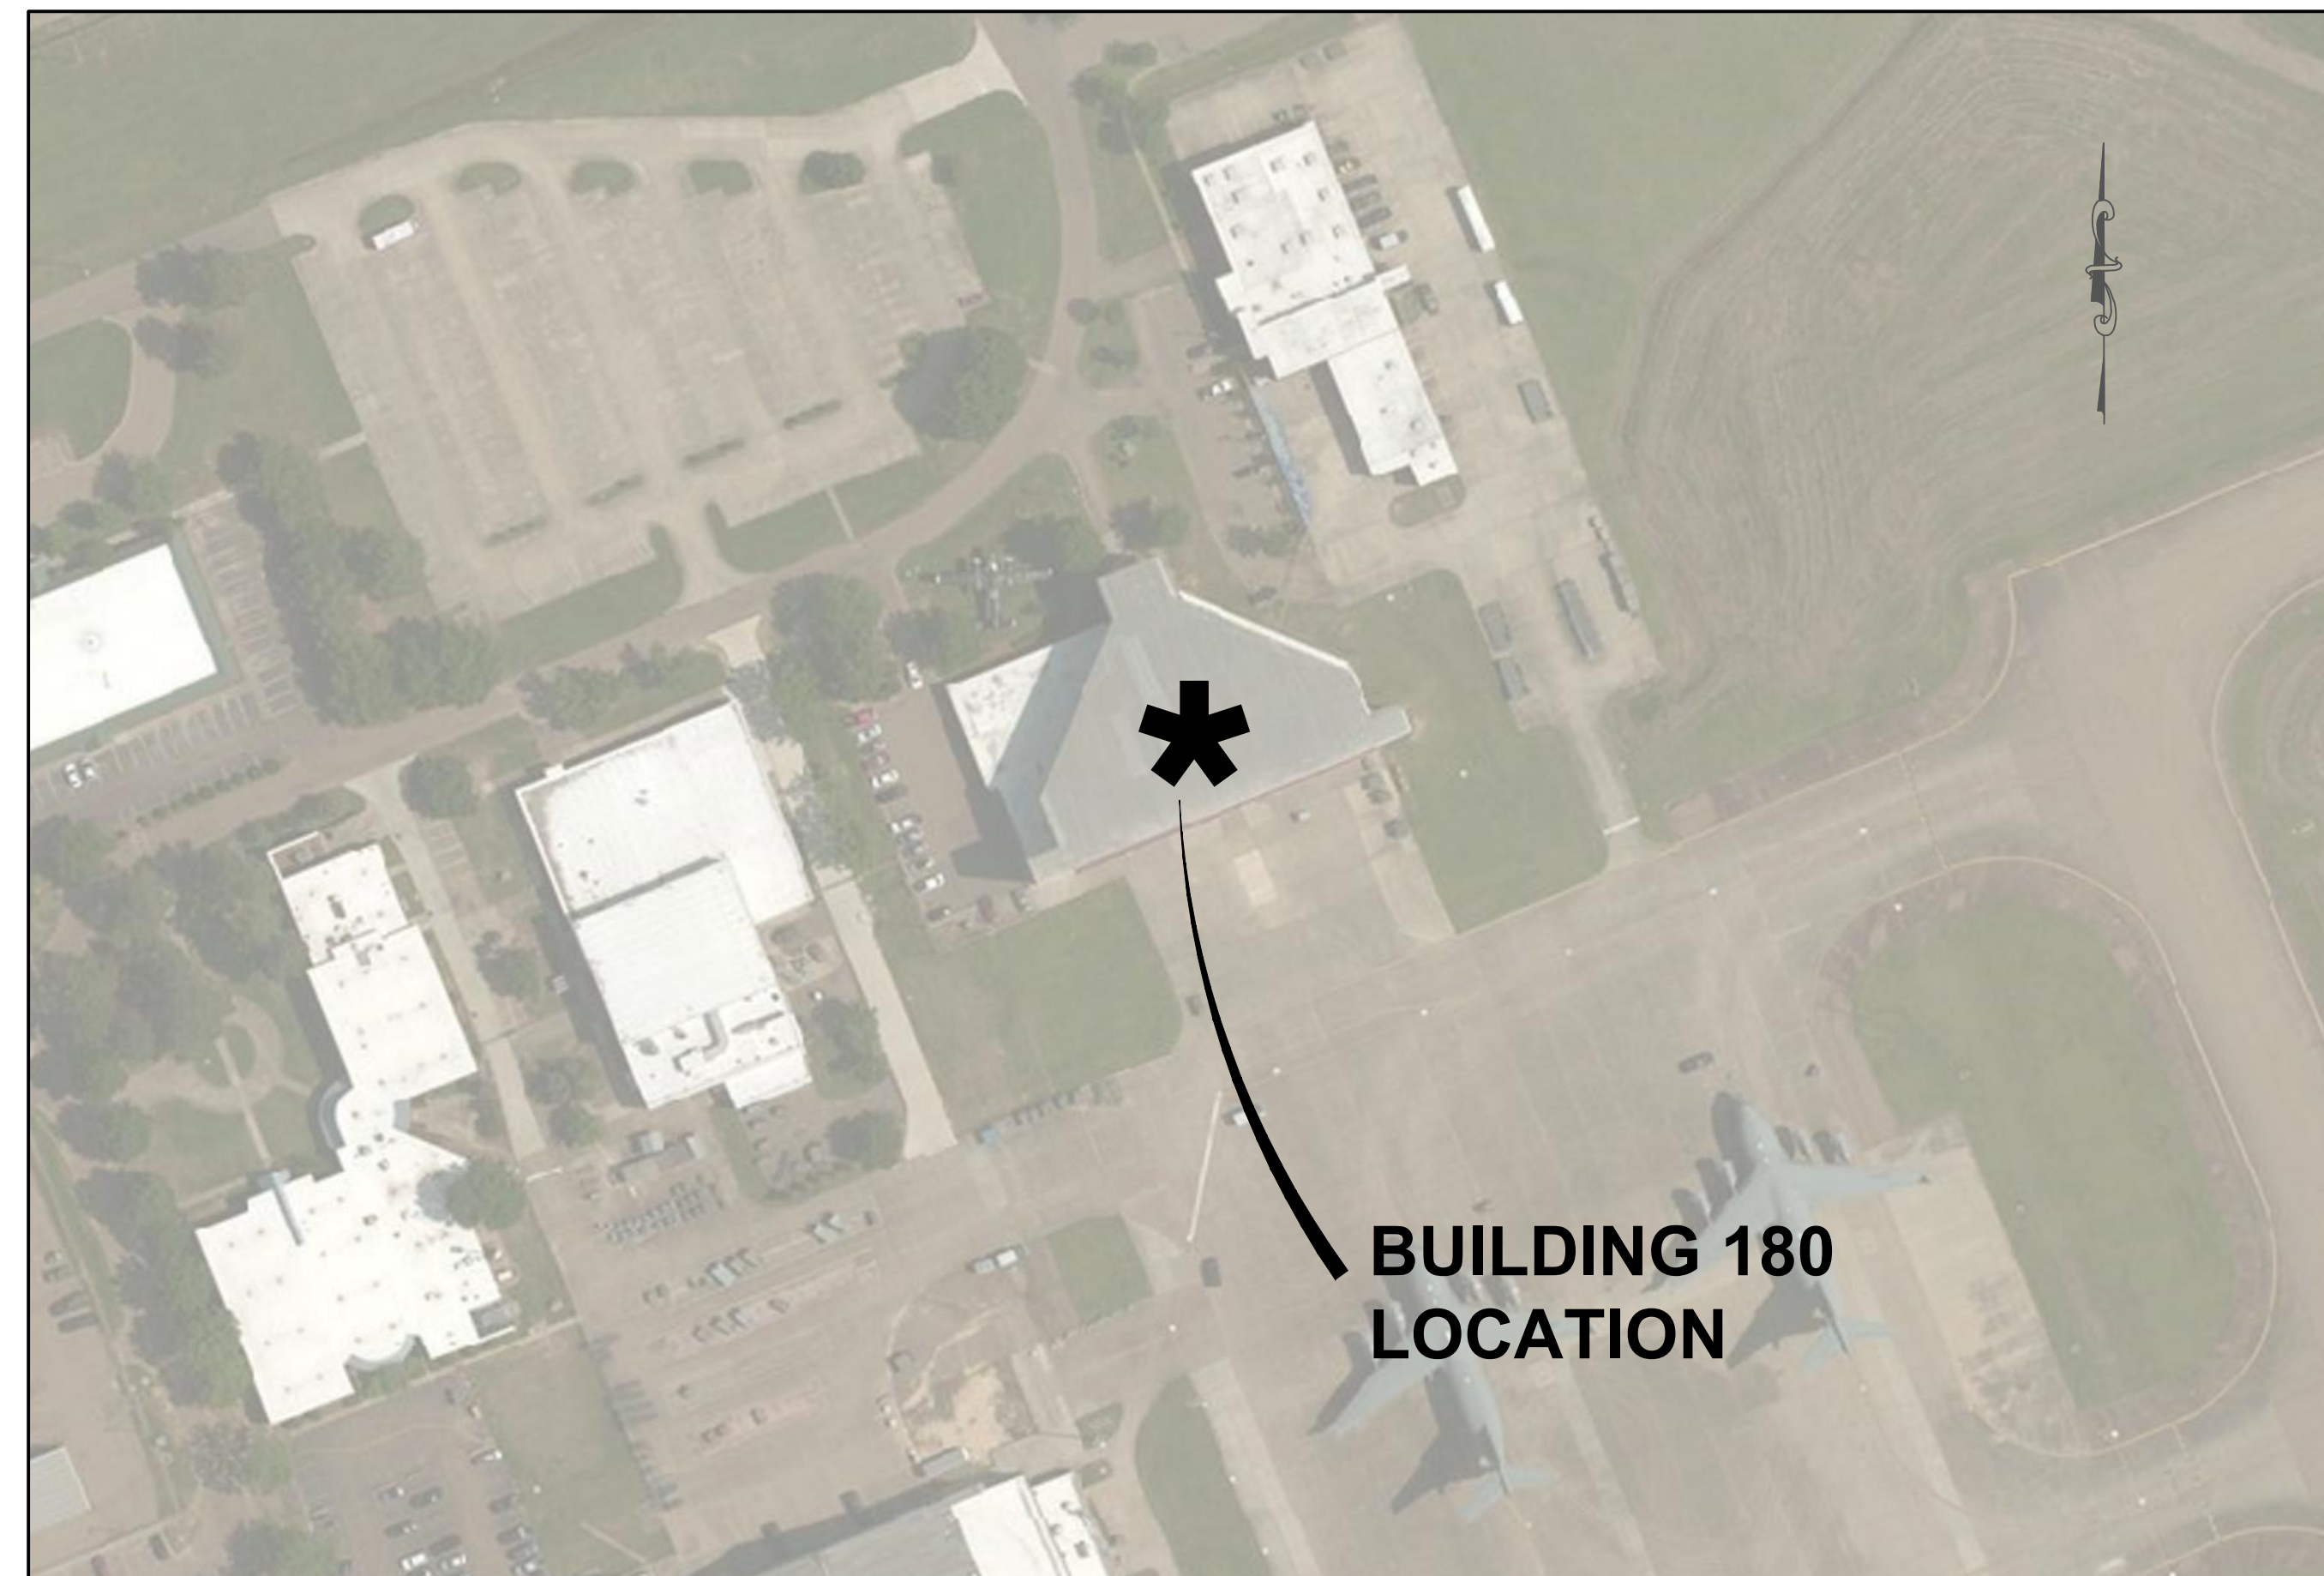

DECEMBER 2023



**MS Air
National Guard**
172 Airlift Wing
141 Military Drive
Jackson, MS 39232




Jon D. Rice & Associates, LLC.
Electrical Engineer
Top Belle Building Services, LLC.
LEED Consultant
Duval Decker Architects, P.A.
Architect

Spencer-Engineers, Inc.
Structural Engineer
Scott Woods & Associates, P.A.
Mechanical Engineer




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STORAGE YARD SCREEN DETAILS

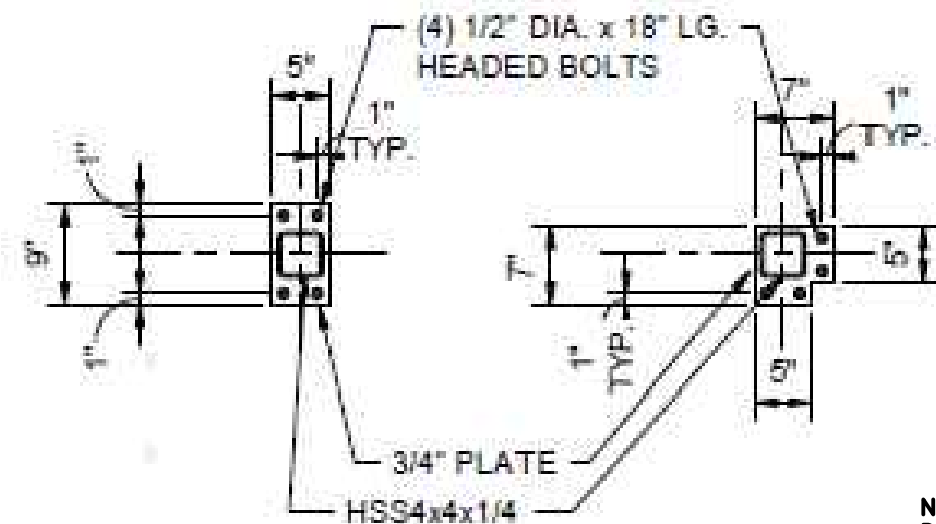

NOTE: COORDINATE ALL SCREENWALL DETAILS WITH ARCHITECTURAL AND STRUCTURAL DRAWINGS.

BASEPLATE DETAILS NOT TO SCALE

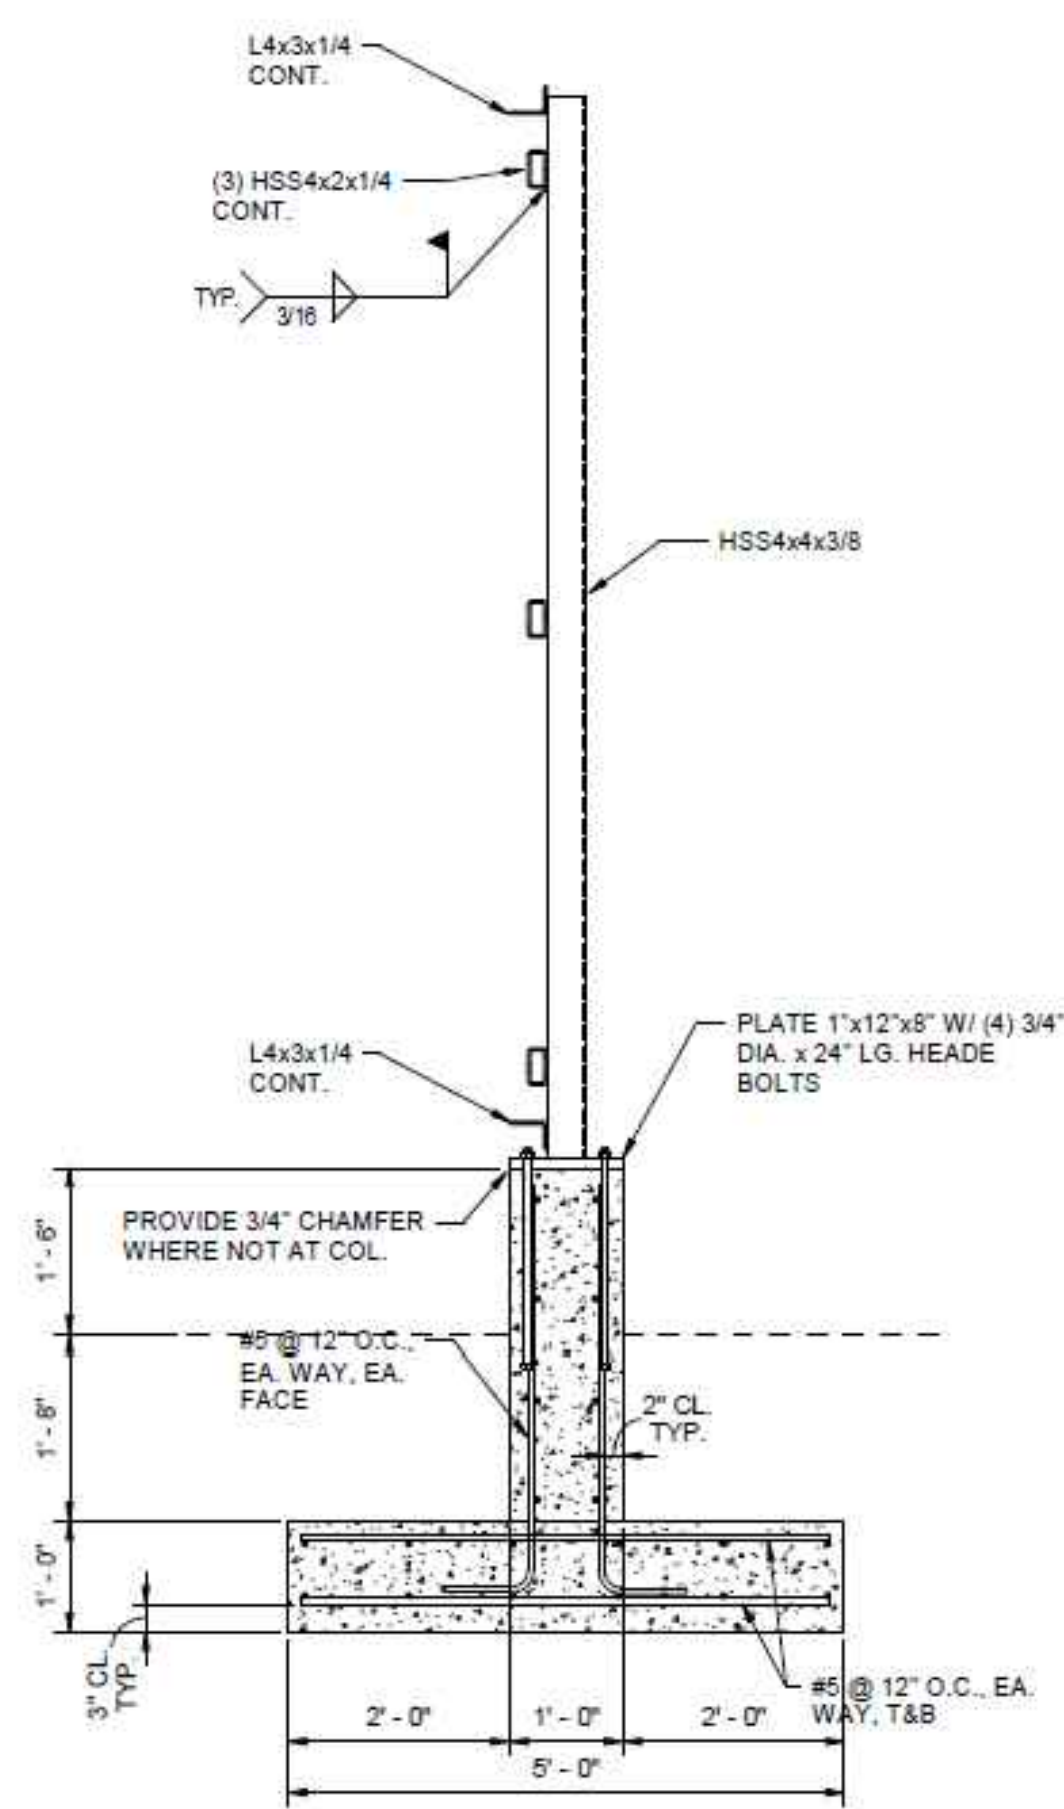

NOTE: (2) 10'-0" SWING GATES TO BE LOCATED IN POSITION BY OWNER. GATE SUPPORT POST TO BE 10" STEEL SQUARE TUBE ON 30" DRILLED PIER 6'-0" DEEP. COORDINATE FOUNDATION LOCATION WITH STRUCTURAL ENGINEER.

SCREEN WALL SECTION DETAIL NOT TO SCALE

INDEX TO DRAWINGS

Table with columns SHEET NO. and TITLE. Lists various drawing sheets from CO.1 to E3.1.

GENERAL CONSTRUCTION NOTES

- 1. CONTRACTOR IS RESPONSIBLE FOR COORDINATION OF ALL REQUIRED UTILITY MODIFICATIONS AND SHALL NOTIFY THE OWNERS OF ALL SAID UTILITIES PRIOR TO COMMENCEMENT OF CONSTRUCTION.
2. THE EXISTING UTILITY LOCATIONS SHOWN ON THE DRAWINGS ARE APPROXIMATE ONLY...

EROSION CONTROL NOTES

- 1. PROVISIONS TO PREVENT EROSION OF SOIL FROM SITE SHALL BE, AT MINIMUM, IN CONFORMANCE WITH THE REQUIREMENTS OF THE MISSISSIPPI DEPARTMENT OF ENVIRONMENTAL QUALITY, BEST MANAGEMENT PRACTICES MANUAL.
2. IMMEDIATELY AFTER THE ESTABLISHMENT OF CONSTRUCTION ENTRANCES/EXITS, IF REQUIRED, ALL PERIMETER EROSION DEVICES AND STORMWATER MANAGEMENT DEVICES SHALL BE INSTALLED PRIOR TO ANY OTHER CONSTRUCTION.

TRAFFIC CONTROL NOTES

- 1. IN AREAS WHERE THE WORK ZONE INCLUDES UNDERCUTTING ADJACENT TO THE EDGE OF PAVEMENT THE CONTRACTOR SHALL UTILIZE STANDARD TRAFFIC DRUMS OR CONCRETE BARRIERS IN ACCORDANCE WITH MDT STANDARD TOP-SC AND THE LATEST EDITION OF THE MUTCD.
2. ALL SIGNS SHALL HAVE DG3 SHEETING, AND CONFORM TO THE LATEST EDITION OF THE MUTCD.



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PROJECT# LRXQ 172402

DRAWING REVISIONS table with columns NO., REMARKS, DATE.



DRAWN BY: TC SCALE: N/A
DESIGNED BY: TC DATE: DEC 2023
CHECKED BY: BG PROJECT: 0513-083.005

GENERAL NOTES & INDEX / FENCE DETAILS

SHEET NUMBER C0.1

UFC 9-7.1.2

When automatic sprinkler protection is required by this UFC, it is meant that a wet pipe sprinkler system is to be provided, unless environmental concerns indicate otherwise (e.g. freezing conditions).

*An automatic sprinkler system (wet pipe) is provided in this building.

UFC 3-600-1 Chapter 9-17 Portable Fire Extinguishers.

*Per UFC 3-600-10 9-17.1 General. General purpose portable fire extinguishers are not required when the facility is provided with complete automatic sprinkler protection and fire alarm system in accordance with this UFC.

*UFC 3-600-10 9-17.2.1 When provided, portable fire extinguishers must be located in accordance with NFPA 10.

*Portable fire extinguishers are provided in this building and will conform to NFPA 10 and IBC.

IBC 906 Portable Fire Extinguishers

Class C Fire Extinguishers must be used for sensitive electronic equipment. NFPA 10 requires the use of carbon dioxide or halogenated agents.

TABLE 906.3.1 - FIRE EXTINGUISHERS FOR CLASS A FIRE HAZARDS. Minimum Rated Single Extinguisher: 2A:10B:C; Maximum Floor Area Per Unit of A: 3,000 sqft; Maximum Floor Area For Extinguisher: 11,250 sqft; Maximum Travel Distance to Extinguisher: 75 ft.

UFC 3-600-1 Chapter 9-18 Fire Alarm System.

UFC 9-18.1.1

Fire alarm systems (detection and notification) must comply with the applicable provisions of NFPA 72 and the ABA, except as modified in this UFC.

*A fire alarm system is provided in this building and will conform to UFC 3-600-1 requirements for detection, notification, and reporting.

CHAPTER 10 - MEANS OF EGRESS

(UFC 3-600-01 IN LIEU OF IBC CHAPTER 10 - USE NFPA 101 CHAPTER 7)

IBC 1004 Occupant Load

IBC TABLE 1004.1.2 - MAX. FLOOR AREA ALLOWANCES PER OCCUPANT (TOTAL OCCUPANCY). Business - 150 sqft per Occupant; Accessory storage/mech - 300 sqft per Occupant; Storage - 300 sqft per Occupant; High Hazard - 300 sqft per Occupant.

NFPA 101 Occupant Load

TABLE 7.3.1.2 FLOOR AREA ALLOWANCES PER OCCUPANT (TOTAL OCCUPANCY). Business - 150 sqft per Occupant; Accessory storage/mech - 300 sqft per Occupant; Storage - 500 sqft per Occupant; High Hazard - 500 sqft per Occupant.

NFPA 7.1.3.1 Exit Access Corridors. Corridors used exit access and serving an area having an occupant load exceeding 30 shall be separated from other parts of the building by walls having not less than a 1-hour fire resistance rating in accordance with Section 8.3, unless otherwise permitted by one of the following:

- (1) This requirement shall not apply to existing buildings, provided that the occupancy classification does not change.
(2) This requirement shall not apply where otherwise provided in Chapters 11 through 43.

*Exit access corridors serve an occupant load greater than 30, however as the occupancy classifications do not change in the altered areas of the existing building, the corridors will not be rated per 7.1.3.1(1) above.

NFPA 7.4 Number of Means of Egress.

7.4.1 General.

7.4.1.1 The number of means of egress from any balcony, mezzanine, story, or portion thereof shall not be less than two, except under one of the following conditions:
(1) A single means of egress shall be permitted where permitted in Chapters 11-43.
(2) A single means of egress shall be permitted for a mezzanine or balcony where the common path of travel limitations of Chapter 11 through 43 are met.

*Per NFPA 12.2.4.5 "Balconies or mezzanines having an occupant load not exceeding 50 shall be permitted to be served by a single means of egress, and such means of egress shall be permitted to lead to the floor below." Given that neither mezzanine has an occupant load greater than 50, they will have only one means of egress. See also IBC 2018. Mezzanines are not primary use areas, are not currently accessible, and will not be accessible.

NFPA 7.5.4 Accessible Means of Egress.

7.5.4.1 Areas accessible to people with severe mobility impairment, other than in existing buildings, shall have not less than two accessible means of egress, unless provided in 7.5.4.1.2 through 7.5.4.1.4.

7.5.4.1.1 Access within the allowable travel distance shall be provided to not less than one accessible area of refuge or one accessible exit providing an accessible route to an exit discharge.

7.5.4.1.4 Exit access travel along the accessible means of egress shall be permitted to be common for the distances permitted as common paths of travel.

7.5.4.2 Where two accessible means of egress are required, the exits serving such means of egress shall be located at a distance from one another not less than on half the length of the maximum overall diagonal dimension of the building or area to be served.

This distance shall be measured in a straight line between the nearest edge of the exit doors or exit access doors, unless otherwise provided in 7.5.4.2.1 through 7.5.4.2.3.

CHAPTER 11 - ACCESSIBILITY

(PER 1200.01 USE ABA STANDARDS AND DOD MEMO. SUBJECT: ACCESS FOR PEOPLE WITH DISABILITIES IN LIEU OF IBC CHAPTER 11)

CHAPTER 2: SCOPING REQUIREMENTS

F201.1 Scope. All areas of newly designed and newly constructed buildings and facilities and altered or leased portions of existing buildings and facilities shall comply with these requirements.

F204 Protruding Objects

F204.1 General. Protruding objects on circulation paths shall comply with 307.

F206 Accessible Routes

F206.1 General. Accessible routes shall be provided in accordance with F206 and shall comply with Chapter 4 except that the exemptions at 403.5, 409.5, and 405.8 shall not apply.

F206.2 Where Required. Accessible routes shall be provided where required by F206.2. F206.2.1 Site Arrival Points. At least one accessible route shall be provided within the site from accessible parking spaces and accessible passenger loading zones, public streets and sidewalks, and public transportation stops to the accessible building or facility entrance they serve.

F206.2.2 Within a Site. At least one accessible route shall connect accessible buildings, accessible facilities, accessible elements, and accessible spaces that are on the same site.

F208 Parking Spaces

F208.1 General. Where parking spaces are provided, parking spaces shall be provided in accordance with F208.

*Parking areas are existing and not being modified.

F213 Toilet Facilities and Bathing Facilities

F213.1 General. Where toilet facilities and bathing facilities are provided, they shall comply with F213. Where toilet facilities and bathing facilities are provided in facilities permitted by F206.2.3 Exceptions 1 and 2 not to connect stories by an accessible route, toilet facilities and bathing facilities shall be provided on a story connected by an accessible route to an accessible entrance.

F213.2 Toilet Rooms and Bathing Rooms. Where toilet rooms are provided, each toilet room shall comply with 603. Where bathing rooms are provided, each bathing room shall comply with 603.

F213.3 Plumbing Fixtures and Accessories. Plumbing fixtures and accessories provided in a toilet room or bathing room required to comply with F213.2 shall comply with F213.3.

F213.3.1 Toilet Compartments. Where toilet compartments are provided, at least one toilet compartment shall comply with 604.8.1. In addition to the compartment required to comply with 604.8.1, at least one compartment shall comply with 604.8.2 where six or

more toilet compartments are provided, or where the combination of urinals and water closets totals six or more fixtures.

F213.3.2 Water Closets. Where water closets are provided at least one shall comply with 604.

F213.3.3 Urinals. Where more than one urinal is provided, at least one shall comply with 605.

F213.3.4 Lavatories. Where lavatories are provided, at least one shall comply with 506 and shall not be located in a toilet compartment.

F213.3.5 Mirrors. Where mirrors are provided, at least one shall comply with 603.3.

F216.4.1 Exit Doors. Doors at exit passageways, exit discharge, and exit stairways shall be identified by tactile signs complying with 703.1, 703.2, and 703.5.

F216.4.3 Directional Signs. Signs required by section 1003.2.13.6 of the International Building Code (2000 edition) or section 1007.7 of the International Building Code (2003 edition) (incorporated by reference, see "Referenced Standards" in Chapter 1) to provide directions to accessible means of egress shall comply with 703.5.

*All modified areas comply with ABA standards.

CHAPTER 8: SPECIAL ROOMS, SPACES, AND ELEMENTS

803.1 General. Dressing, fitting, and locker rooms shall comply with 803.

803.4 Benches. A bench complying with 903 shall be provided in the room.

*No ABA bench will be provided per request in email from Major Roberts on 05/31/23.

CHAPTER 29 - PLUMBING SYSTEMS

(CHAPTER 29 AS MODIFIED BY UFC 3-600-01)

IBC 2902 Minimum Plumbing Facilities

[P] 2902.1 Minimum number of fixtures. Plumbing fixtures shall be provided in the minimum number as shown in Table 2902.1 based on the actual use of the building or space. Uses not shown in Table 2902.1 shall be considered individually by the code official. The number of occupants shall be determined by this code.

[P] 2902.1.1 Fixture calculations. To determine the occupant load of each sex, the total occupant load shall be divided in half. To determine the required number of fixtures, the fixture ratio or ratios for each fixture type shall be applied to the occupant load of each sex in accordance with Table 2902.1. Fractional numbers resulting from applying the fixture ratios of Table 2902.1 shall be rounded up to the next whole number. For calculations involving multiple occupancies, such fractional numbers for each occupancy shall first be summed and then rounded up to the next whole number.

Exception: The total occupant load shall not be required to be divided in half where approved statistical data indicate a distribution of the sexes of other than 50 percent of each sex.

*The owner (AB National Guard/Government) provided program data and requirements for unequal distribution of fixtures per actual use of the building. Due to the majority male occupancy, more male fixtures are provided for water closets, lavatories, and showers.

IPC 403 Minimum Plumbing Facilities

TABLE 403.1 - MINIMUM NUMBER OF REQUIRED PLUMBING FIXTURES. Water Closets: 4 men / 4 women; Lavatories: 3 men / 3 women; Showers: 2 men / 2 women; Drinking Fountains: 2 total; Service Sinks: 1 per floor.

8 (Per UFC 3-600-01 IPC Chapter 4 Supplement D) *Business - Air Force

TABLE 8.2 - MINIMUM NUMBER OF REQUIRED PLUMBING FIXTURES. Total 42 Occupants / 2 - 44 MALE/FEMALE. Water Closets (1/20) (Male): 3; Water Closets (1/20) (Female): 3; Lavatories (1/20): 3 EA Male and Female; Showers (1/20): 1 EA Male and Female; Drinking Fountains: 1 (per 7500); Service Sinks: 1 (per floor).

5 (Per 403.1) Total 72,000 Occupants / 2 - 10 MALE/FEMALE

TABLE 5.2 - MINIMUM NUMBER OF REQUIRED PLUMBING FIXTURES. Water Closets (1/10) (Male): 1; Water Closets (1/10) (Female): 1; Lavatories (1/100): 1 EA Male and Female; Drinking Fountains (1/100): 1; Service Sinks: 1.



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172ND AIRLIFT WING
PROJECT# LRXQ 172402

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Professional seals for Roy T. Decker, Registered Architect (No. 2879) and Lonne Marie Decker, Registered Architect (No. 3044), both in the State of Mississippi, dated September 27, 2023.

DRAWING TITLE table with fields for DRAWN BY, DESIGNED BY, CHECKED BY, DRAWING TITLE, SCALE, and DATE.

CODE SUMMARY

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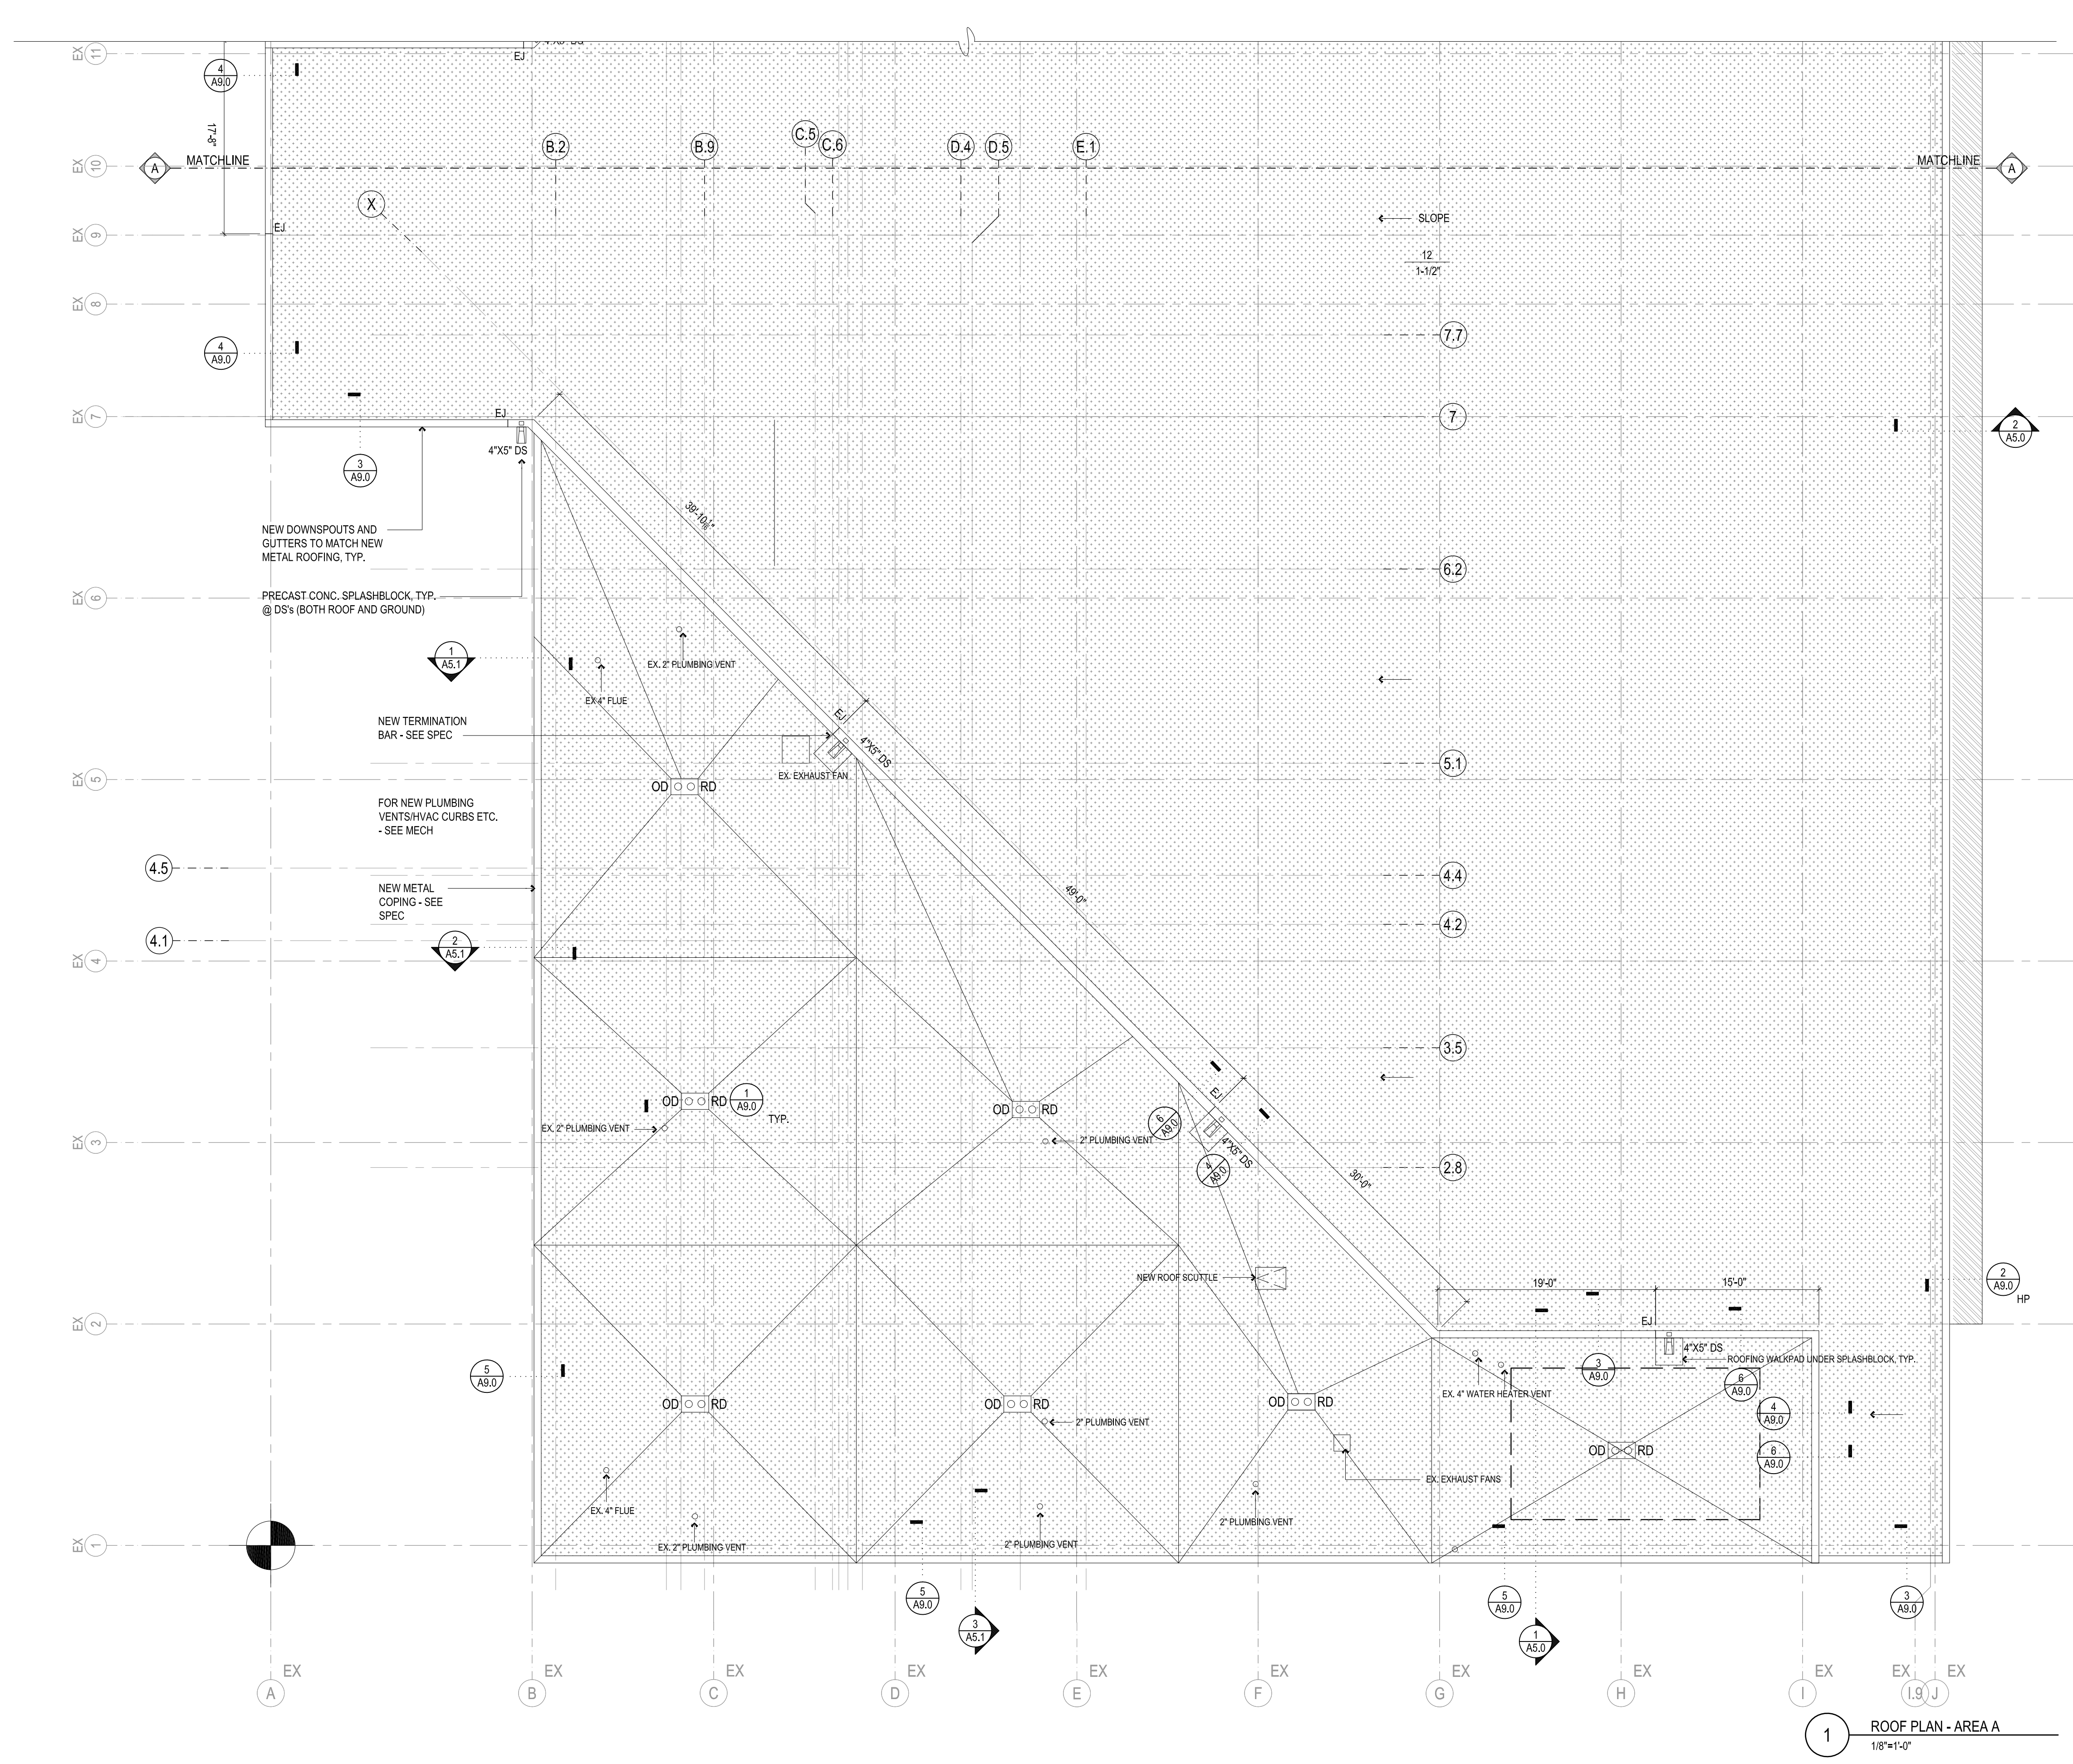
DRAWING REVISIONS		
NO.	REMARKS	DATE

ROY T. DECKER
REGISTERED ARCHITECT
2879
MISSISSIPPI
SEPTEMBER 27, 2023

LINDA MARIE DECKER
REGISTERED ARCHITECT
3044
JACKSON, MS
SEPTEMBER 27, 2023



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DESIGNED BY: MCH/AMD DATE: SEPTEMBER 2023
CHECKED BY: AMD PROJECT: LRXQ172402
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PARTIAL
ROOF PLAN
SHEET NUMBER
A1.3A




ROOF PLAN LEGEND

- NEW T.P.O. ROOFING - SEE SPEC
- EXISTING ROOF TO BE REPAIRED - SEE SPEC
- DOWNSPOUT
- ROOF DRAIN / OVERFLOW DRAIN
- NEW VENT THROUGH ROOF - SEE MECH
- 6" DOWNSPOUT W/ CONC. SPLASHBLOCK

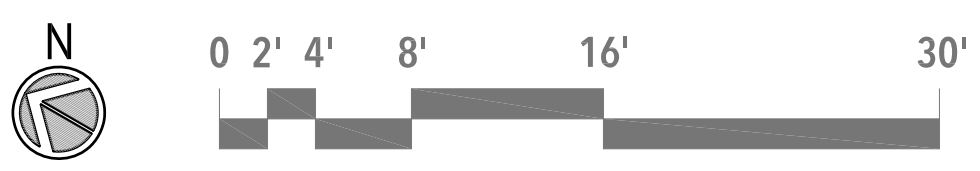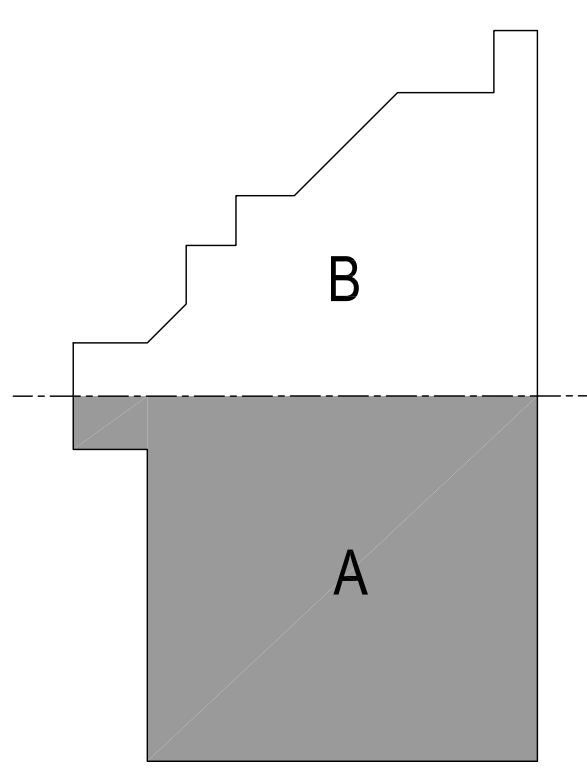


1 ROOF PLAN - AREA A
1/8"=1'-0"

**RENOVATE BASE SUPPLY
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PROJECT# LRXG 172402

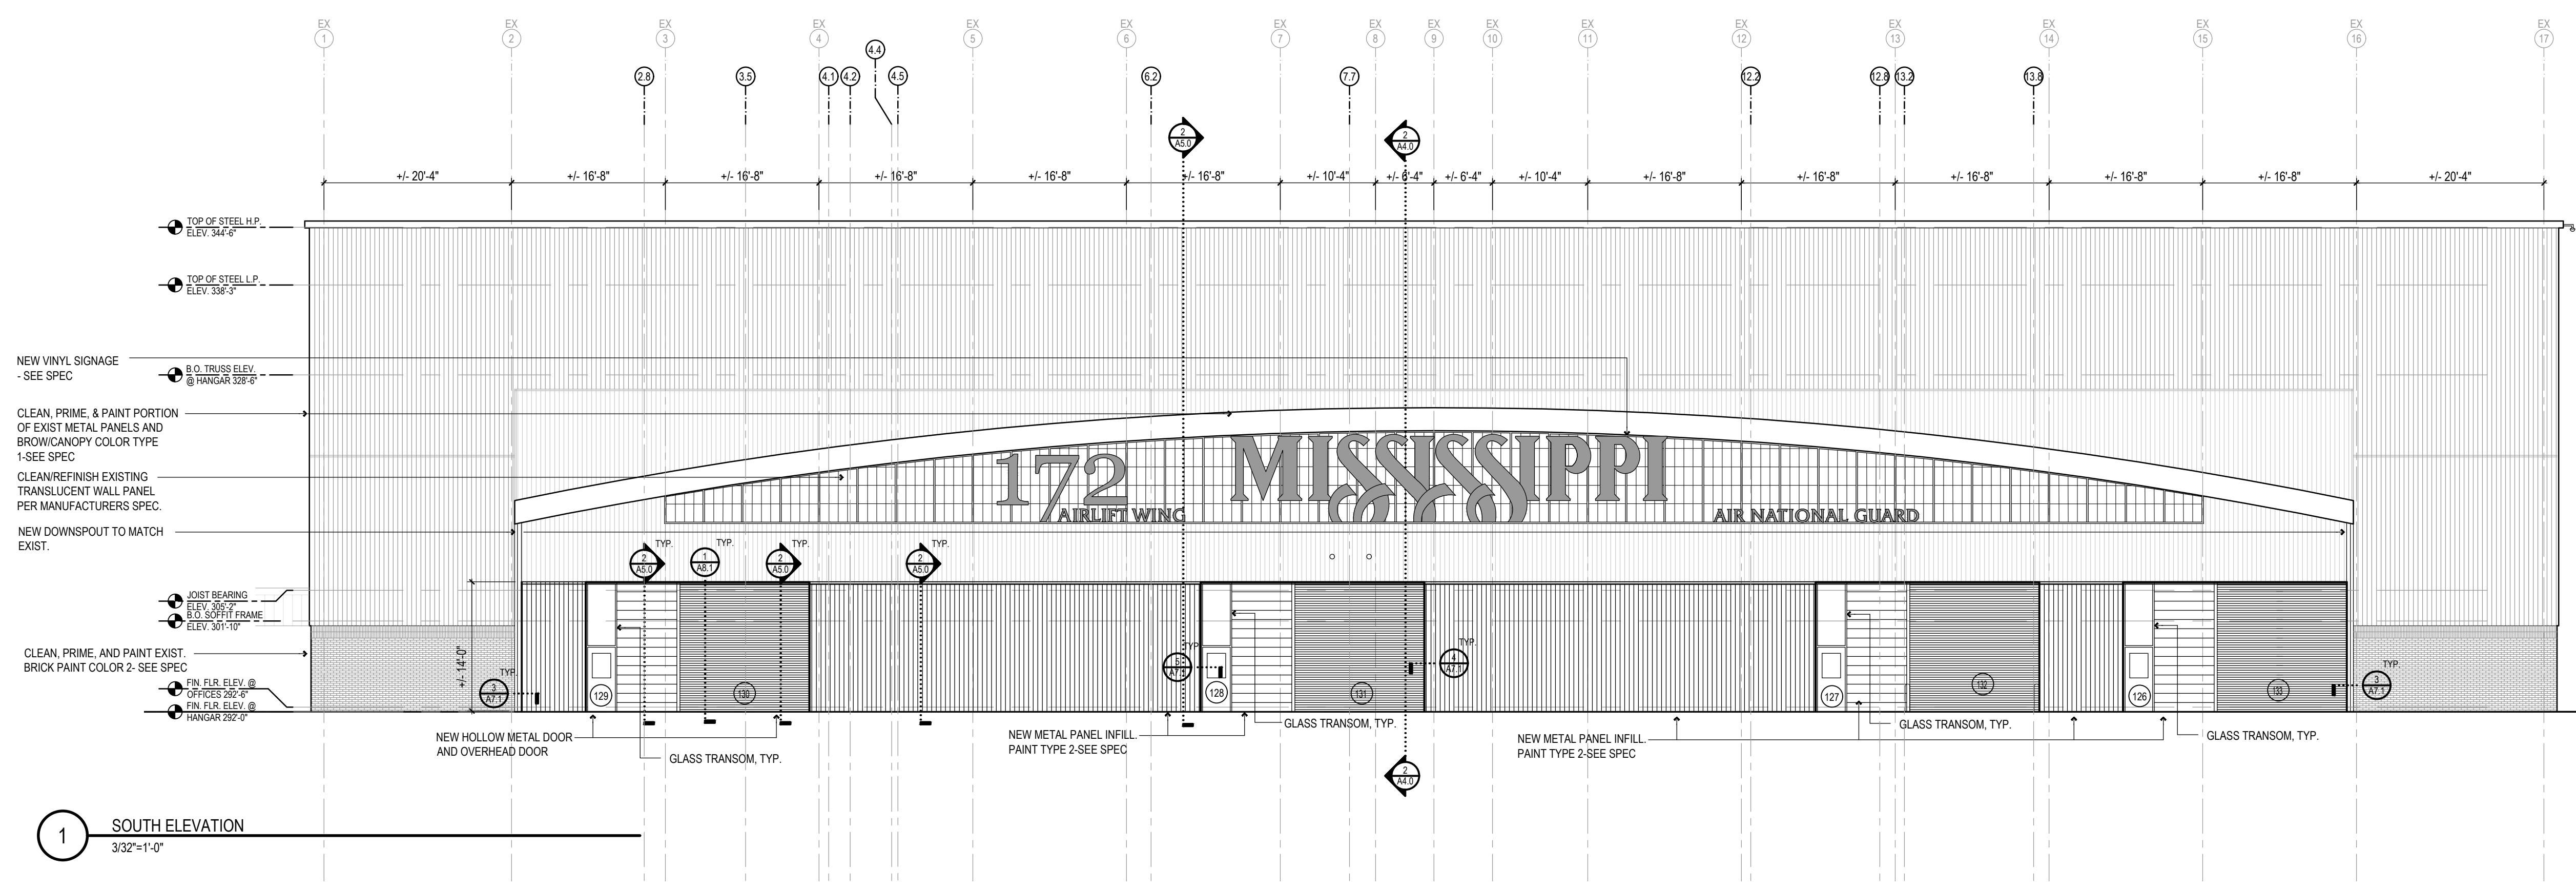


1 SOUTH ELEVATION
3/32"=1'-0"

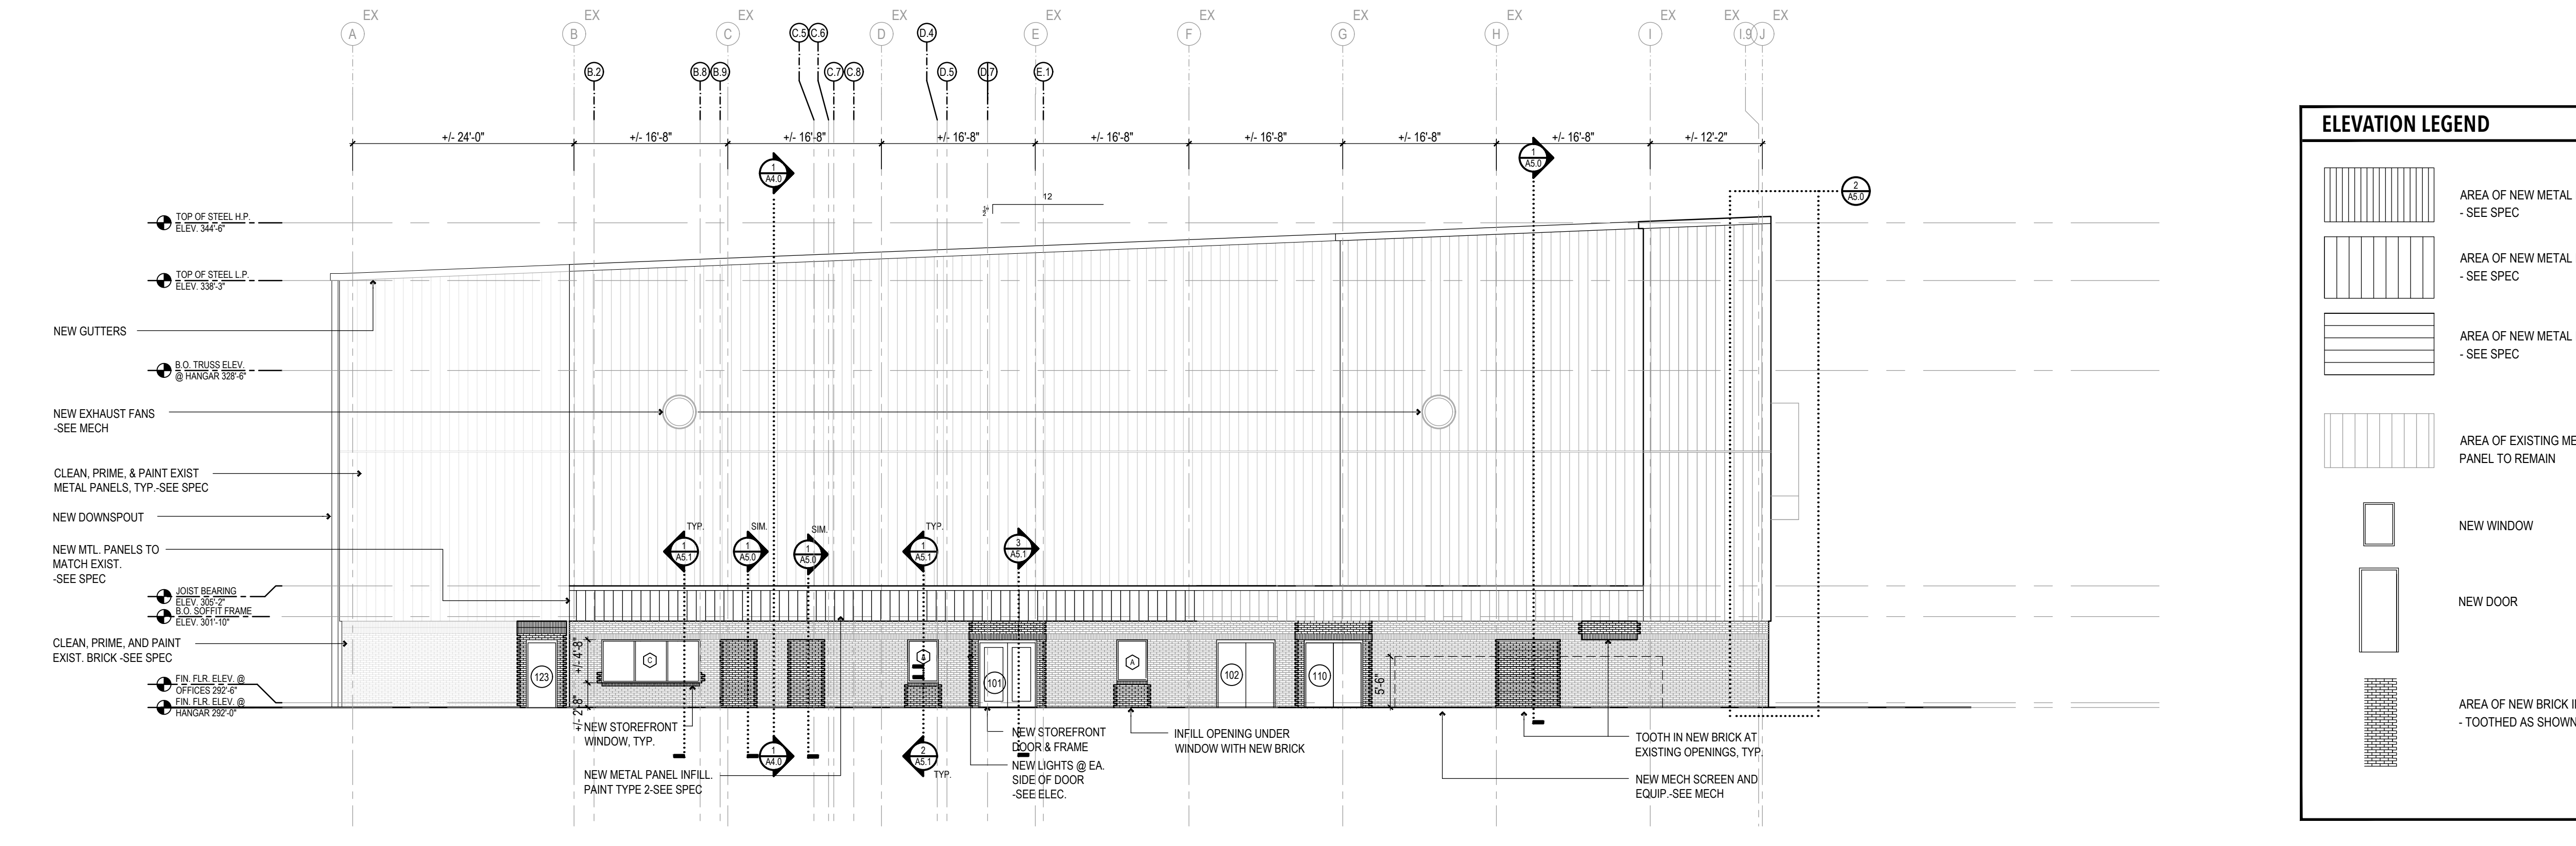

2 WEST ELEVATION
3/32"=1'-0"

ELEVATION LEGEND

- AREA OF NEW METAL PANEL TYPE 1 - SEE SPEC
- AREA OF NEW METAL PANEL TYPE 2 - SEE SPEC
- AREA OF NEW METAL PANEL TYPE 3 - SEE SPEC
- AREA OF EXISTING METAL WALL PANEL TO REMAIN
- NEW WINDOW
- NEW DOOR
- AREA OF NEW BRICK INFILL - TOOTHED AS SHOWN

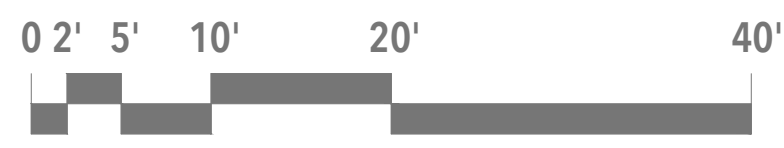

DRAWING REVISIONS		
NO.	REMARKS	DATE


SEAL:

SEPTEMBER 27, 2023


SEPTEMBER 27, 2023

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DESIGNED BY: MCH/AMD DATE: SEPTEMBER 2023
CHECKED BY: AMD PROJECT: LRXG172402
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SHEET NUMBER: **A3.0**

**RENOVATE BASE SUPPLY
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PROJECT# LRXQ 172402

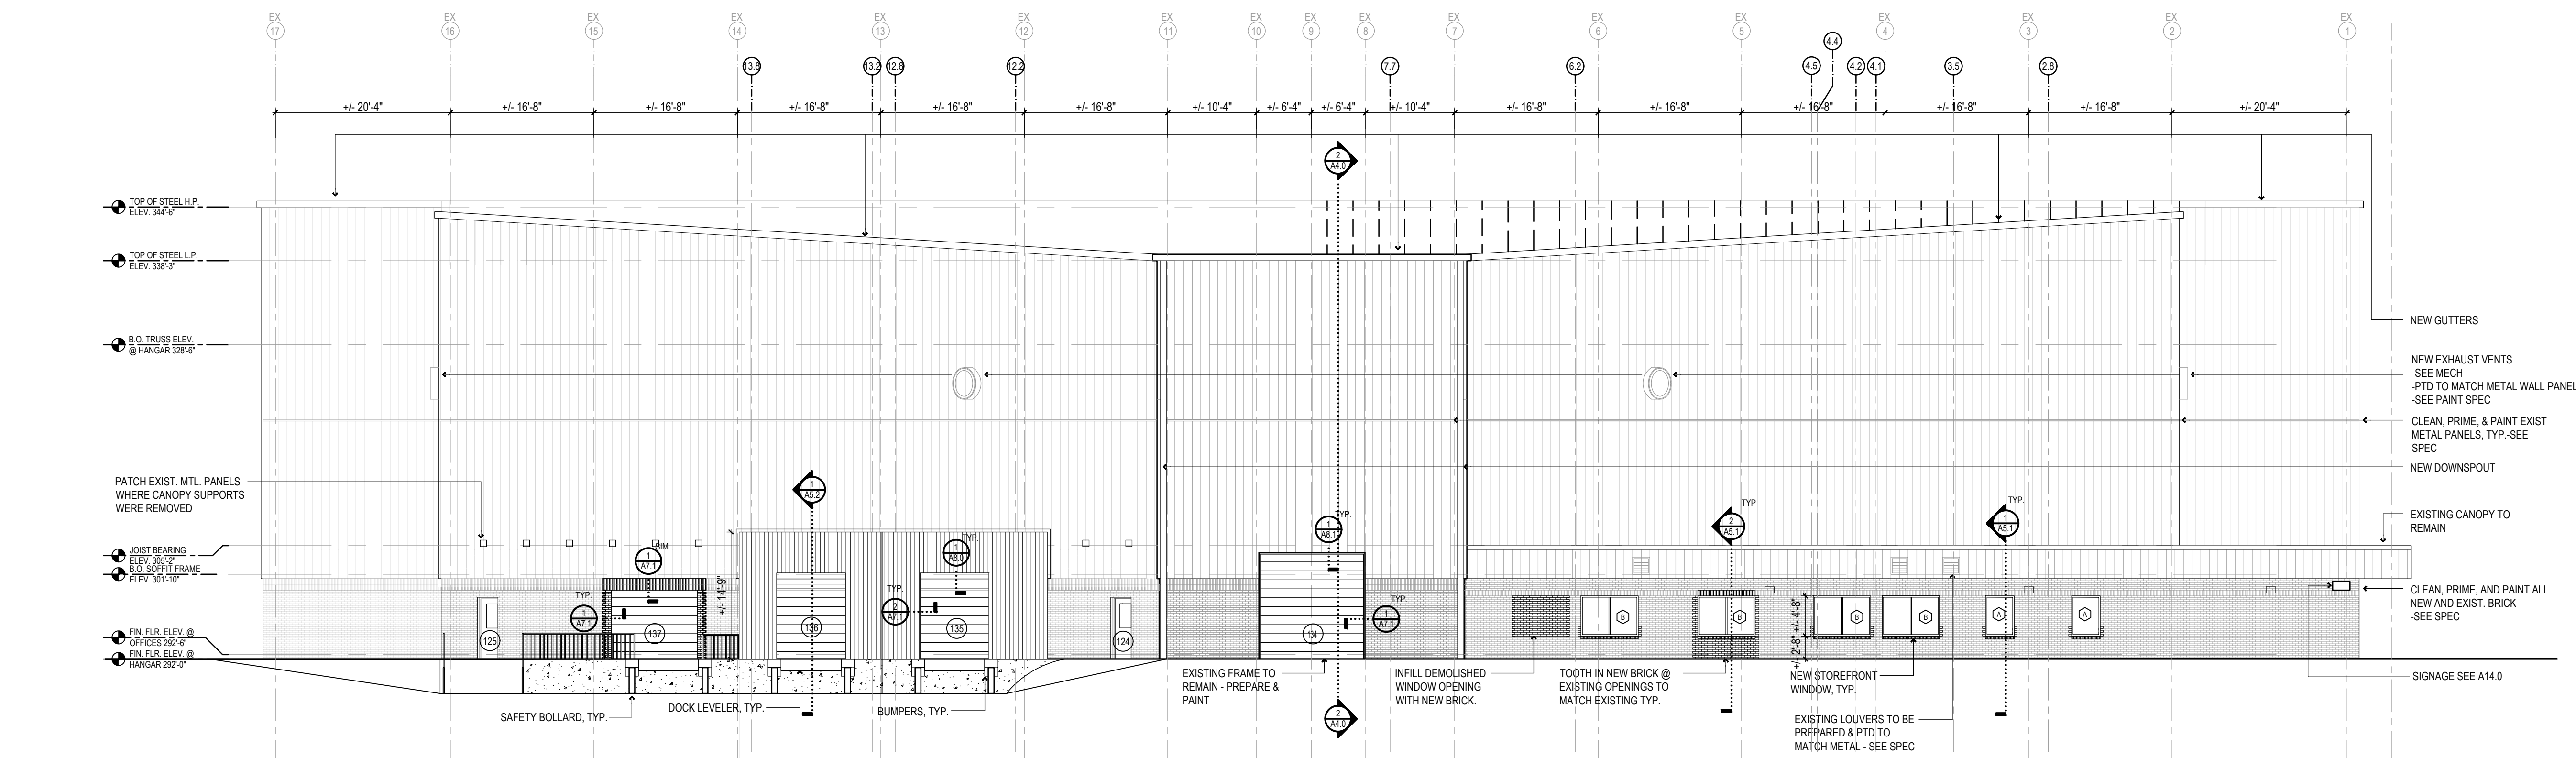


1 NORTH ELEVATION
3/32"=1'-0"

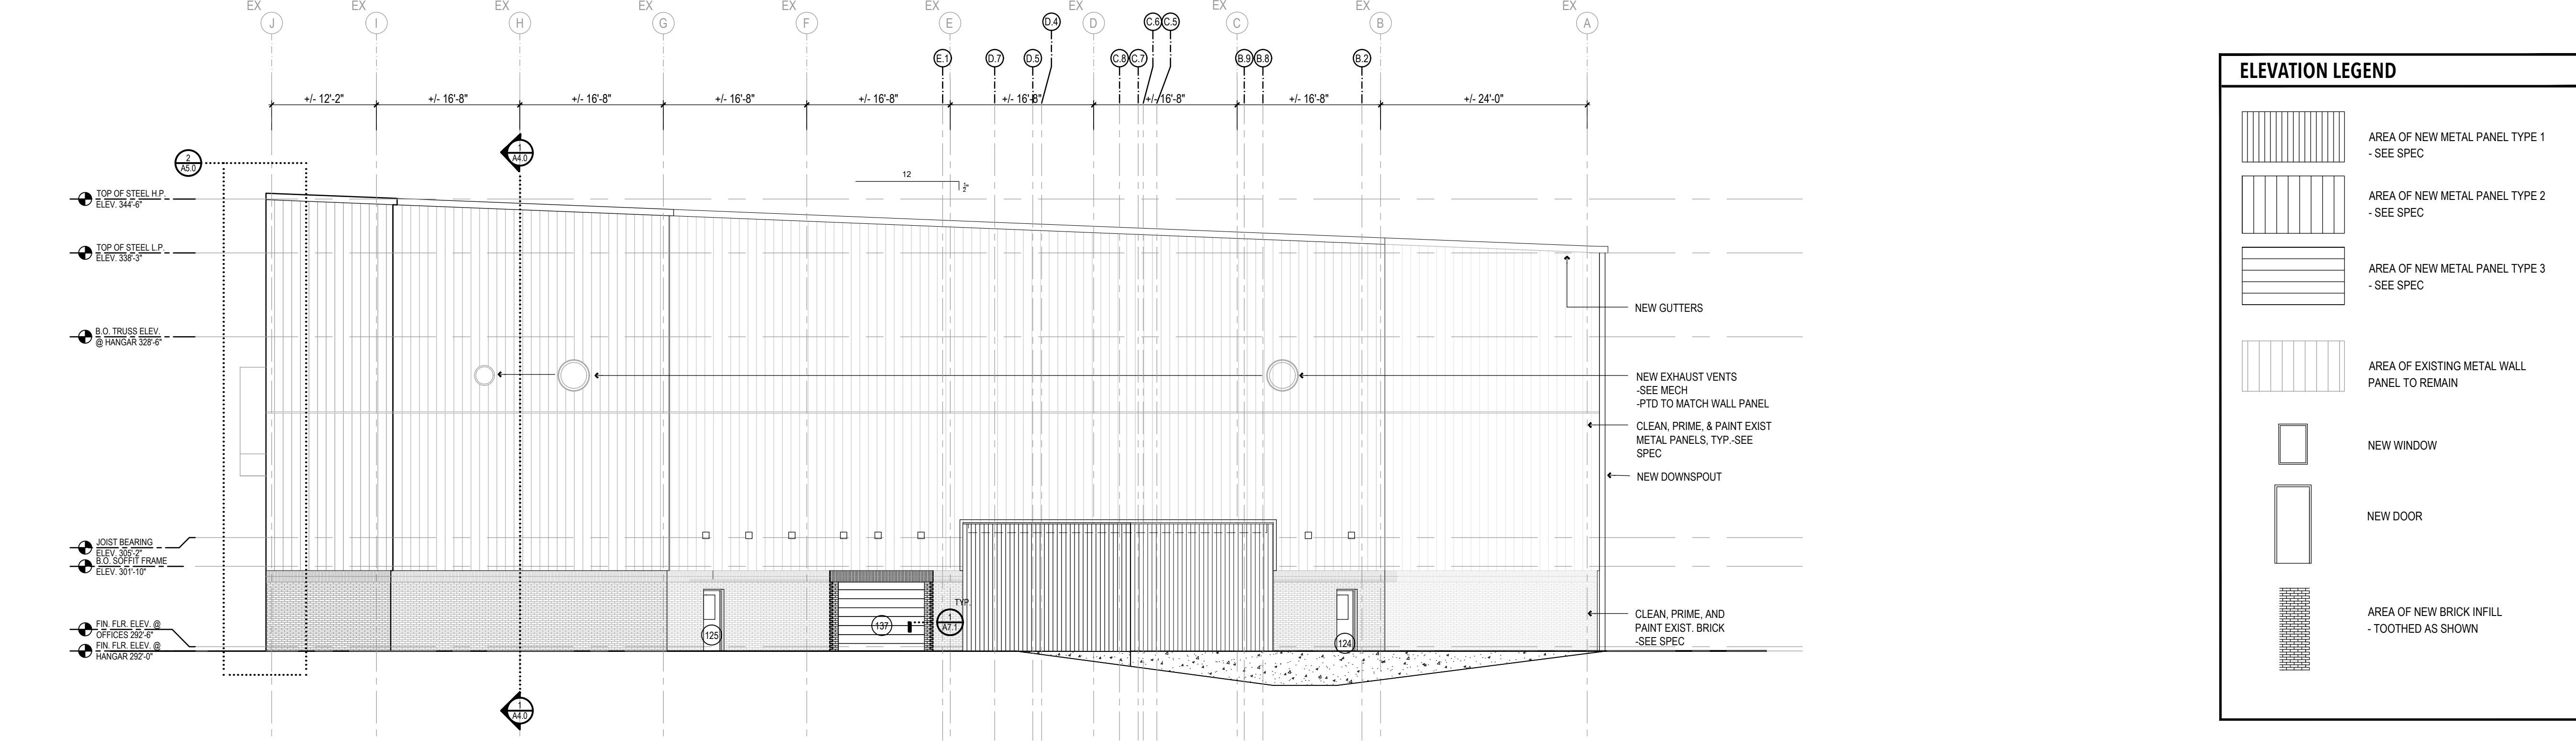

2 EAST ELEVATION
3/32"=1'-0"

ELEVATION LEGEND

- AREA OF NEW METAL PANEL TYPE 1 - SEE SPEC
- AREA OF NEW METAL PANEL TYPE 2 - SEE SPEC
- AREA OF NEW METAL PANEL TYPE 3 - SEE SPEC
- AREA OF EXISTING METAL WALL PANEL TO REMAIN
- NEW WINDOW
- NEW DOOR
- AREA OF NEW BRICK INFILL - TOOTHED AS SHOWN

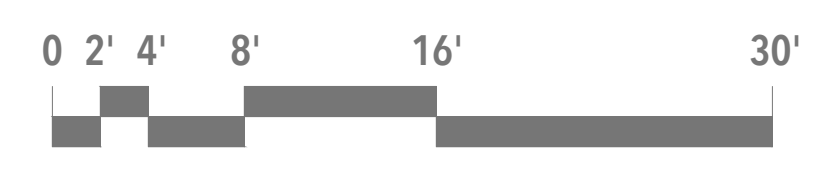

DRAWING REVISIONS

NO.	REMARKS	DATE


SEAL:

SEPTEMBER 27, 2023

SEPTEMBER 27, 2023

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DESIGNED BY: MCH/AMD	DATE: SEPTEMBER 2023
CHECKED BY: AMD	PROJECT: LRXQ172402
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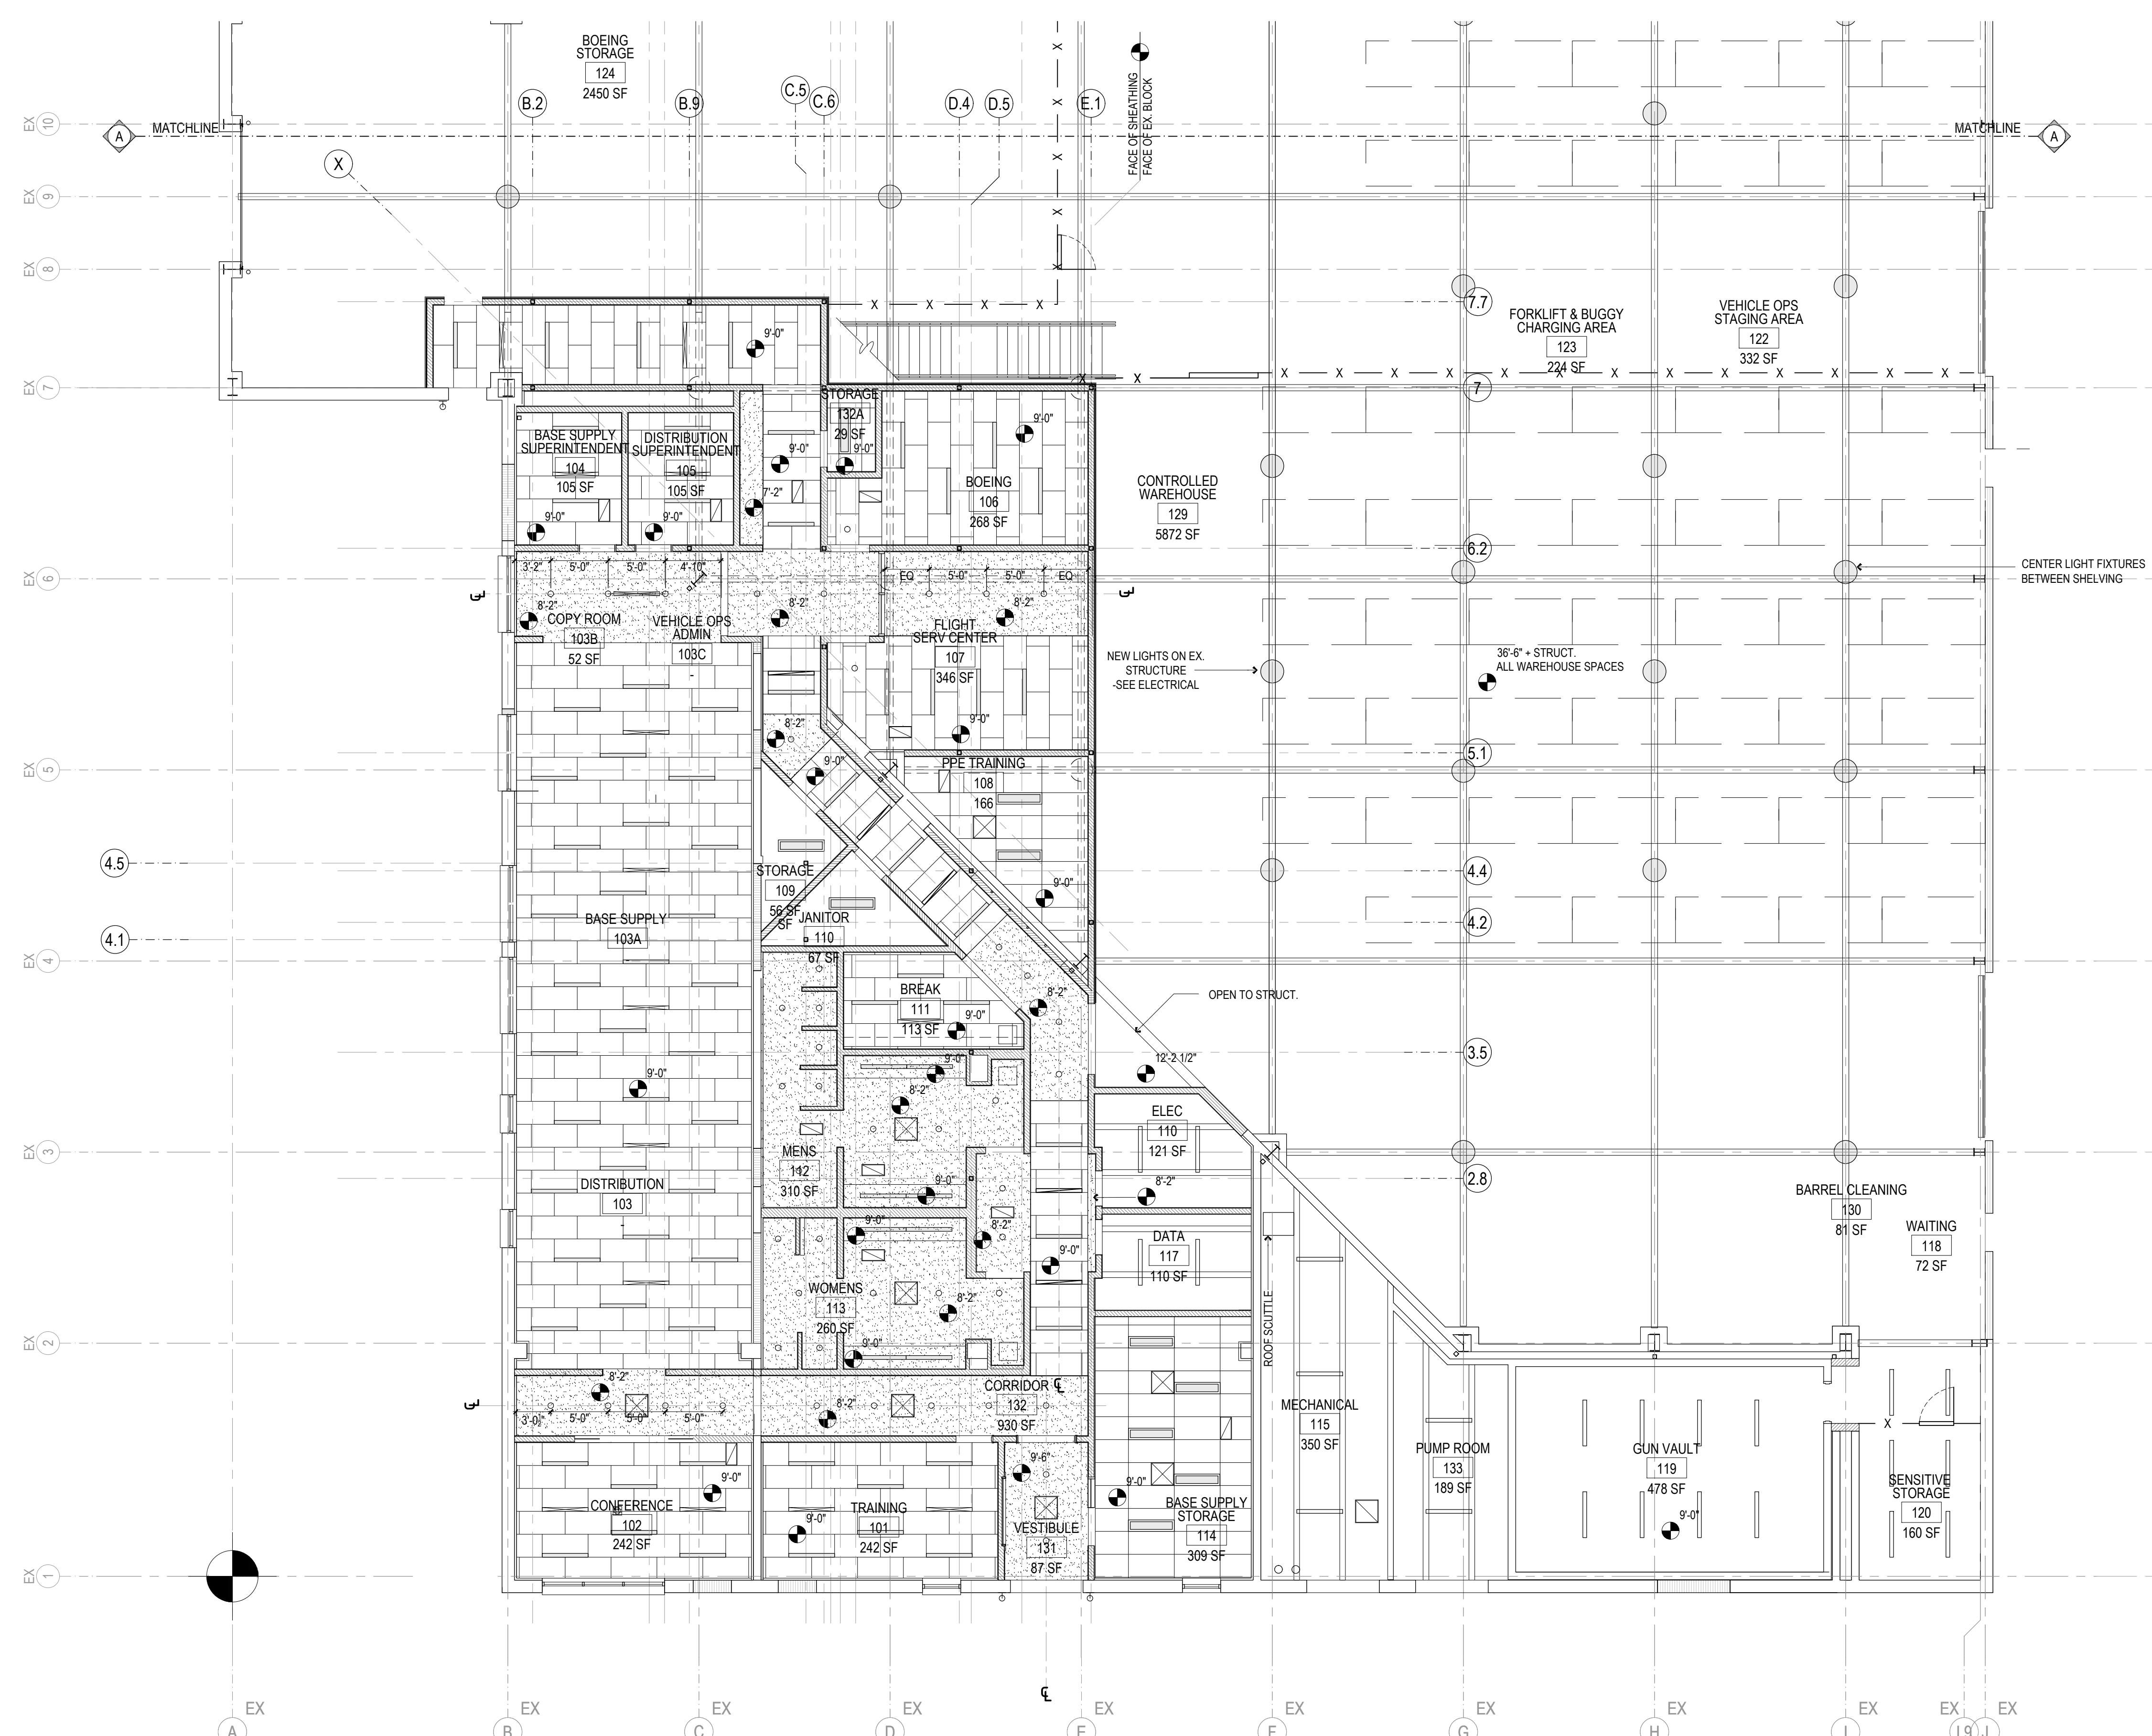
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NO.	REMARKS	DATE

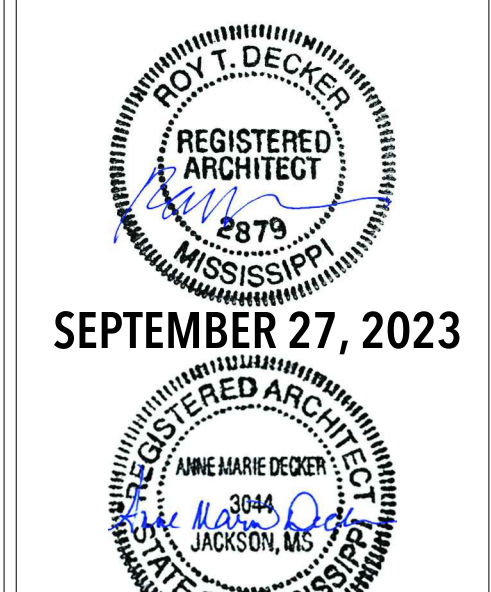

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DESIGNED BY: MCH/AMD	DATE: SEPTEMBER 2023
CHECKED BY: AMD	PROJECT: LRXQ172402
DRAWING TITLE	

FIRST FLOOR REFLECTED
CEILING PLAN-AREA A


SHEET NUMBER
A12.1A



NOTE:
1) CENTER LIGHT FIXTURES BETWEEN SHELVING IN WAREHOUSE WHERE SHELVING OCCURS BELOW. CENTER ON STRUCTURE AT OTHER LOCATIONS IN WAREHOUSE AS SHOWN.

REFLECTED CEILING PLAN LEGEND


- METAL PANEL
- NEW ACT CEILING & SUPPORT GRID
- NEW GYP. BD.
- NEW SPECIAL GYP. BD.
- EXISTING STRUCTURE - PTD.
- SOUND BATT INSULATION
- HVAC SUPPLY DIFFUSER
- LINEAR SUPPLY DIFFUSER
- HVAC RETURN DIFFUSER
- 2x2 RECESSED TROFFER
- 6" RECESSED DOWNLIGHT
- LINEAR LIGHT PENDANT MOUNTED
- LINEAR LIGHT FIXTURE SURFACE MOUNTED
- 9'-4" DROPPED CEILING HEIGHT ABOVE FLOOR
- TAPE LIGHT

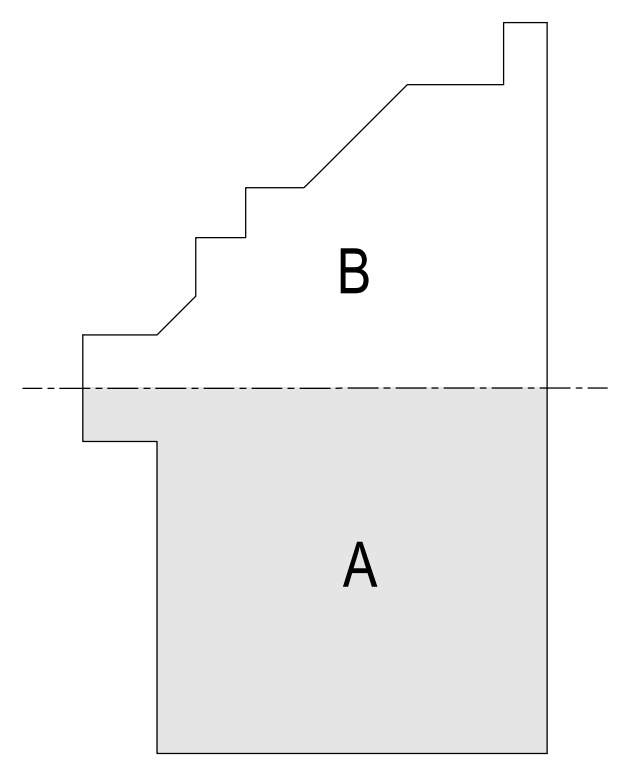

1 RCP-01 AREA A
1/8"=1'-0"



FOUNDATION AND FLOOR FRAMING PLAN
1/8" = 1'-0"

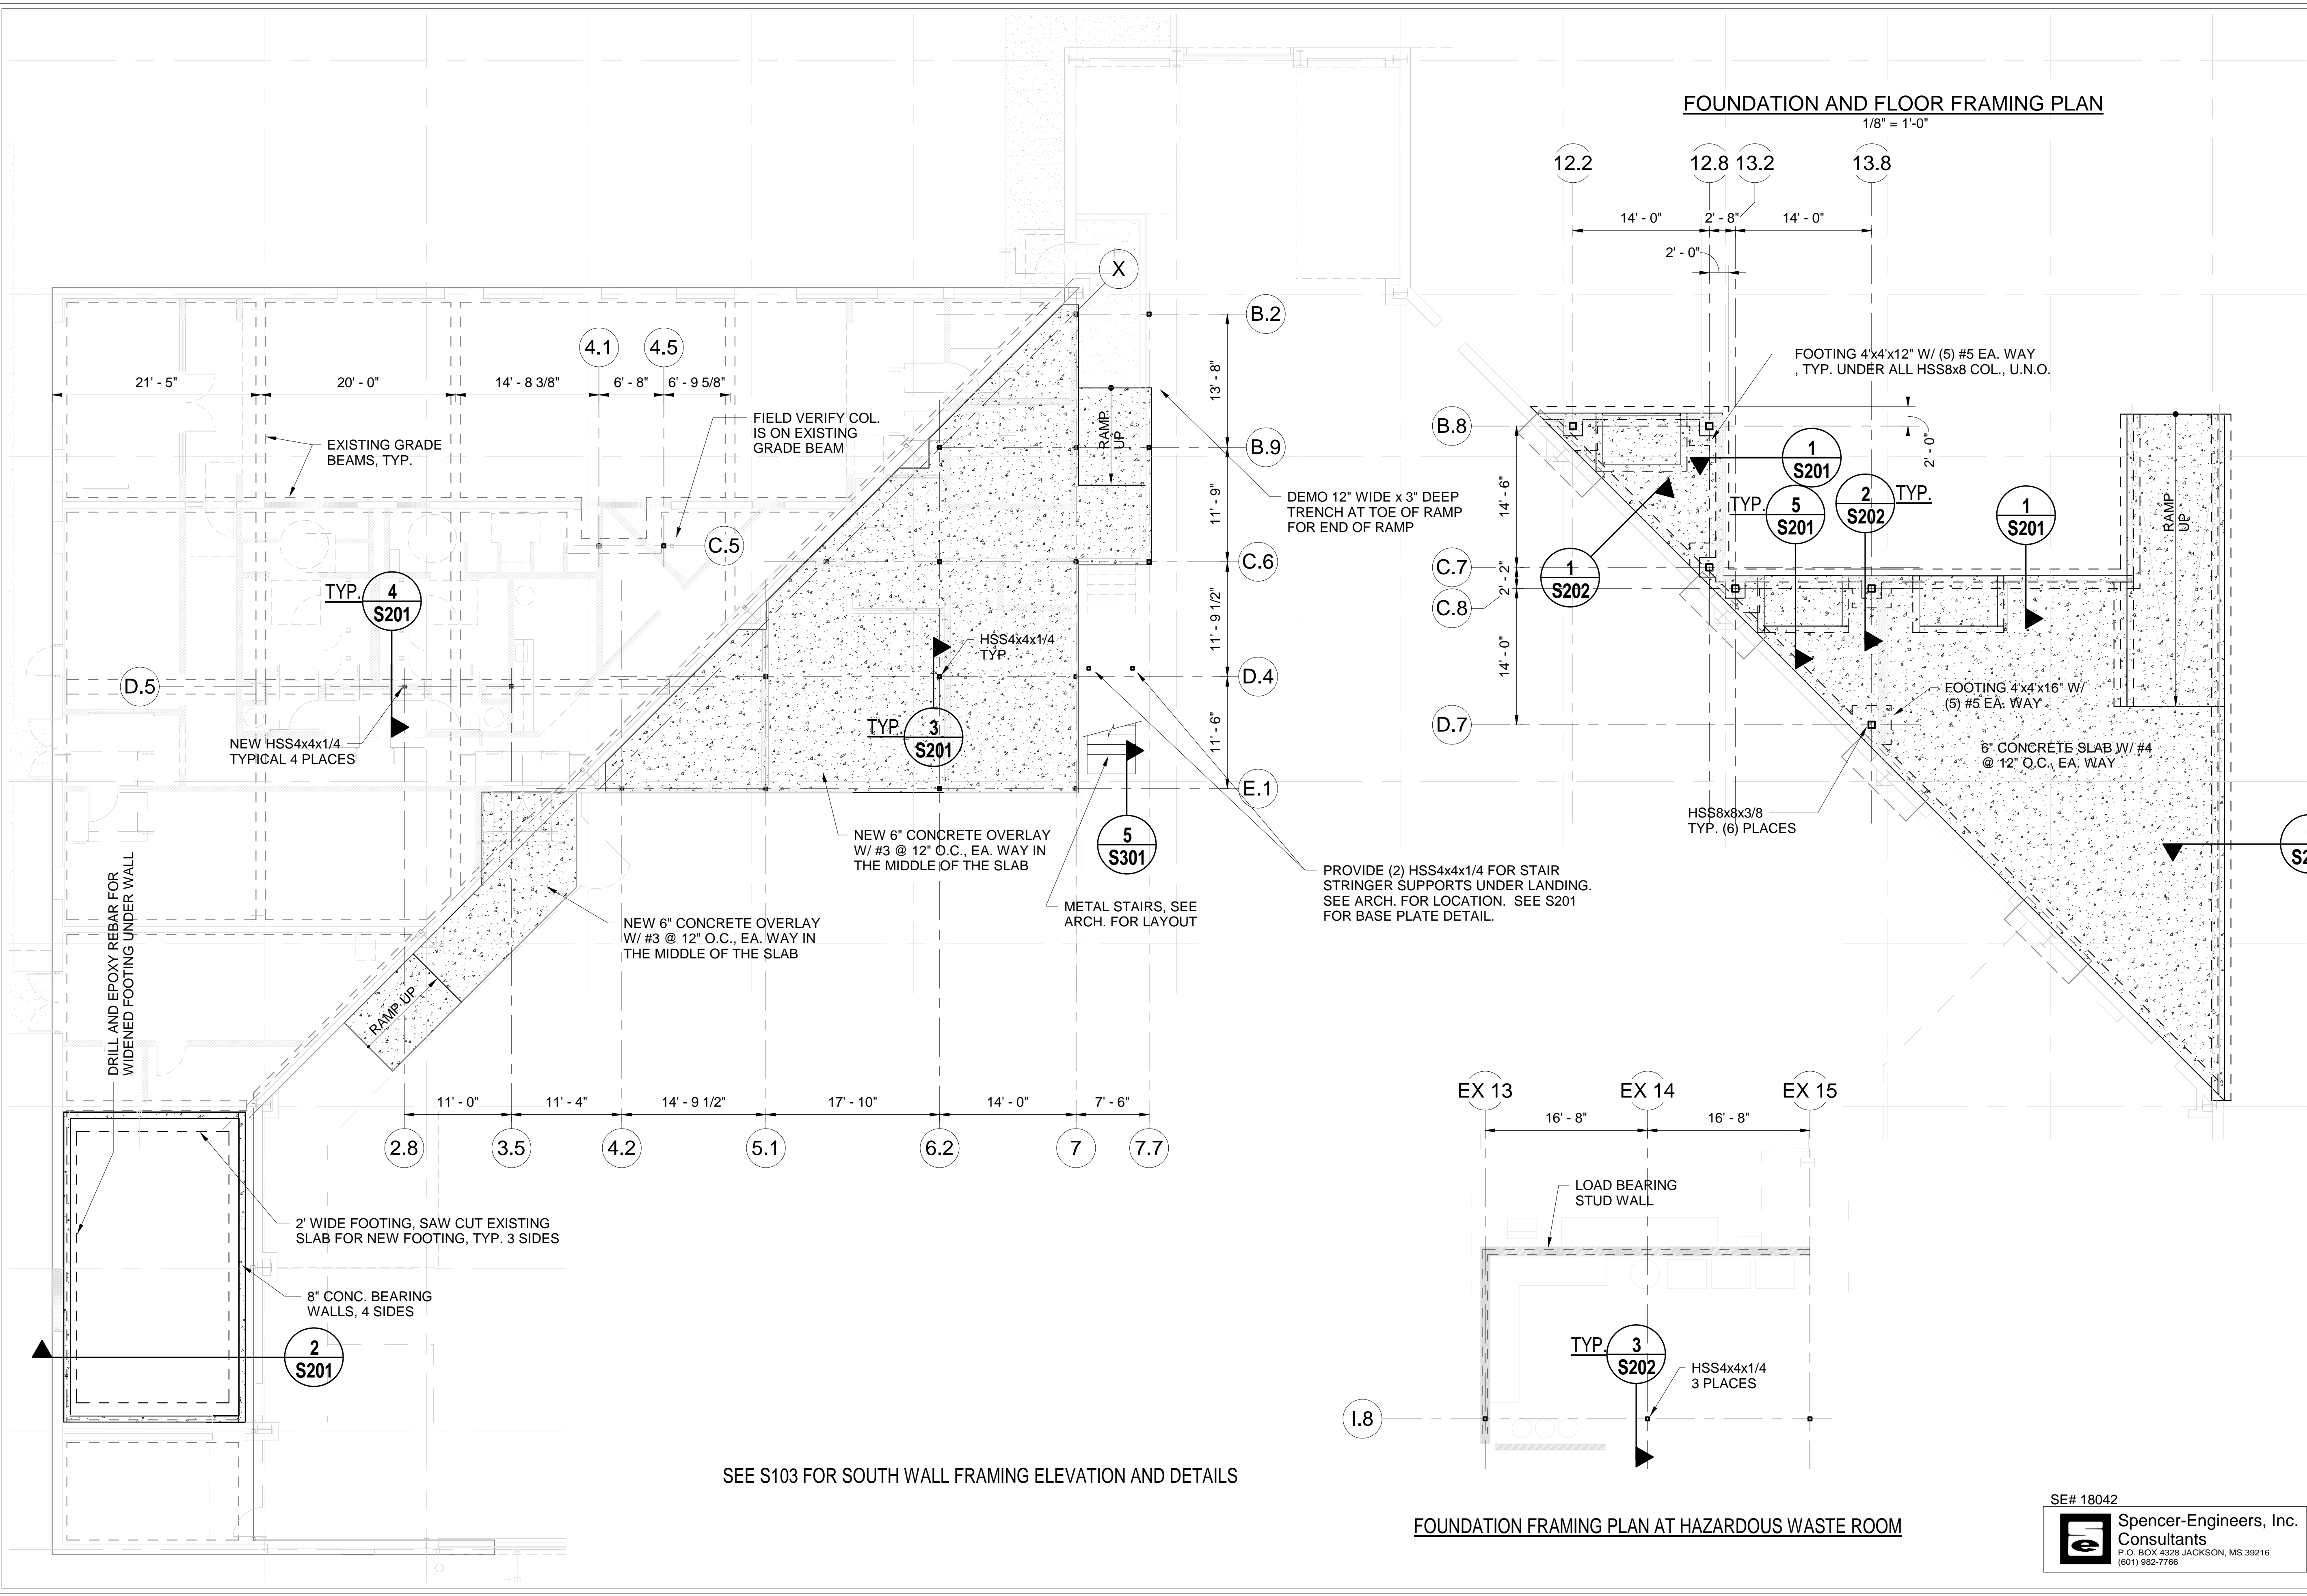


SEE S103 FOR SOUTH WALL FRAMING ELEVATION AND DETAILS

FOUNDATION FRAMING PLAN AT HAZARDOUS WASTE ROOM

SE# 18042
Spencer-Engineers, Inc. Consultants
P.O. BOX 4328 JACKSON, MS 39216
(601) 962-7766

DRAWING REVISIONS		
NO.	REMARKS	DATE

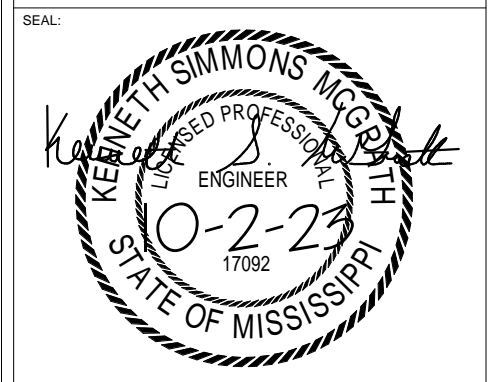

DRAWN BY: KSM	SCALE: 1/8" = 1'-0"
DESIGNED BY: KSM	DATE: SEPT. 2023
CHECKED BY: KSM	PROJECT: #####

DRAWING TITLE:
FOUNDATION AND FLOOR FRAMING PLAN

SHEET NUMBER:
S101


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NO.	REMARKS	DATE



DRAWN BY: KSM SCALE: As Indicated
DESIGNED BY: KSM DATE: SEPT 2023
CHECKED BY: KSM PROJECT: #####
DRAWING TITLE:

ROOF AND
MEZZANINE
FRAMING PLAN


SHEET NUMBER:
S102

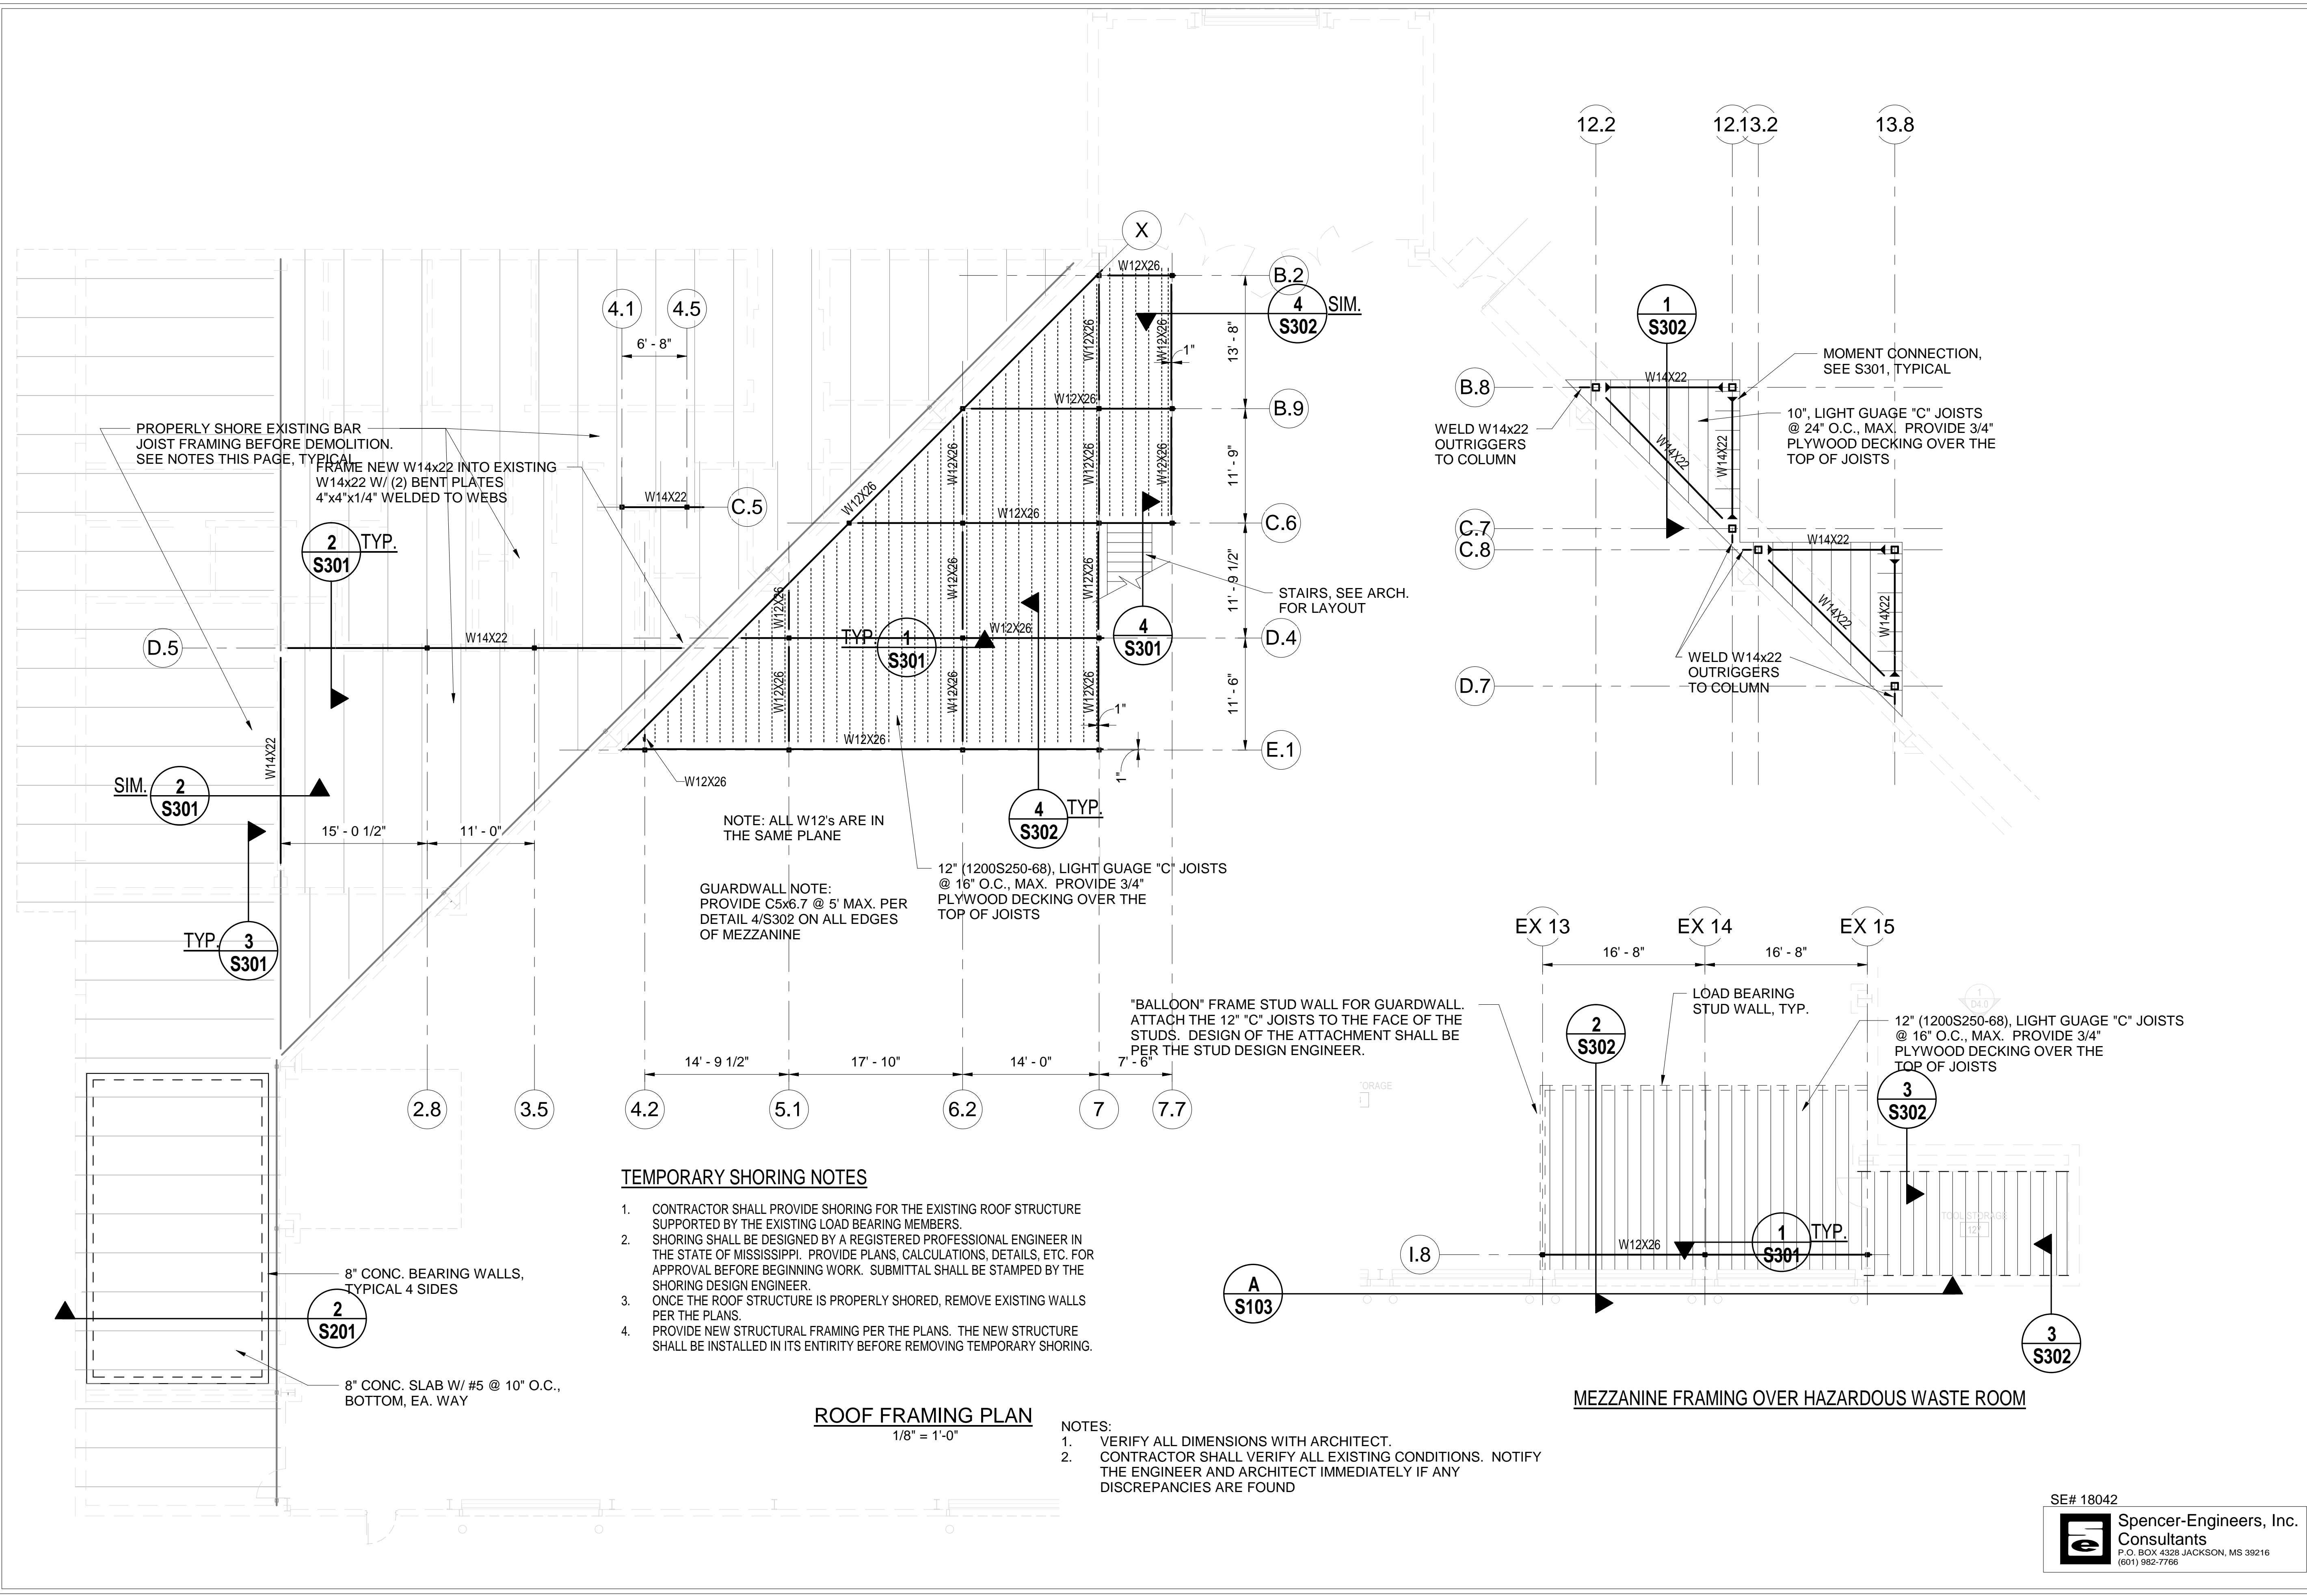

- TEMPORARY SHORING NOTES**
- CONTRACTOR SHALL PROVIDE SHORING FOR THE EXISTING ROOF STRUCTURE SUPPORTED BY THE EXISTING LOAD BEARING MEMBERS.
 - SHORING SHALL BE DESIGNED BY A REGISTERED PROFESSIONAL ENGINEER IN THE STATE OF MISSISSIPPI. PROVIDE PLANS, CALCULATIONS, DETAILS, ETC. FOR APPROVAL BEFORE BEGINNING WORK. SUBMITTAL SHALL BE STAMPED BY THE SHORING DESIGN ENGINEER.
 - ONCE THE ROOF STRUCTURE IS PROPERLY SHORED, REMOVE EXISTING WALLS PER THE PLANS.
 - PROVIDE NEW STRUCTURAL FRAMING PER THE PLANS. THE NEW STRUCTURE SHALL BE INSTALLED IN ITS ENTIRTY BEFORE REMOVING TEMPORARY SHORING.


ROOF FRAMING PLAN
1/8" = 1'-0"

- NOTES:**
- VERIFY ALL DIMENSIONS WITH ARCHITECT.
 - CONTRACTOR SHALL VERIFY ALL EXISTING CONDITIONS. NOTIFY THE ENGINEER AND ARCHITECT IMMEDIATELY IF ANY DISCREPANCIES ARE FOUND

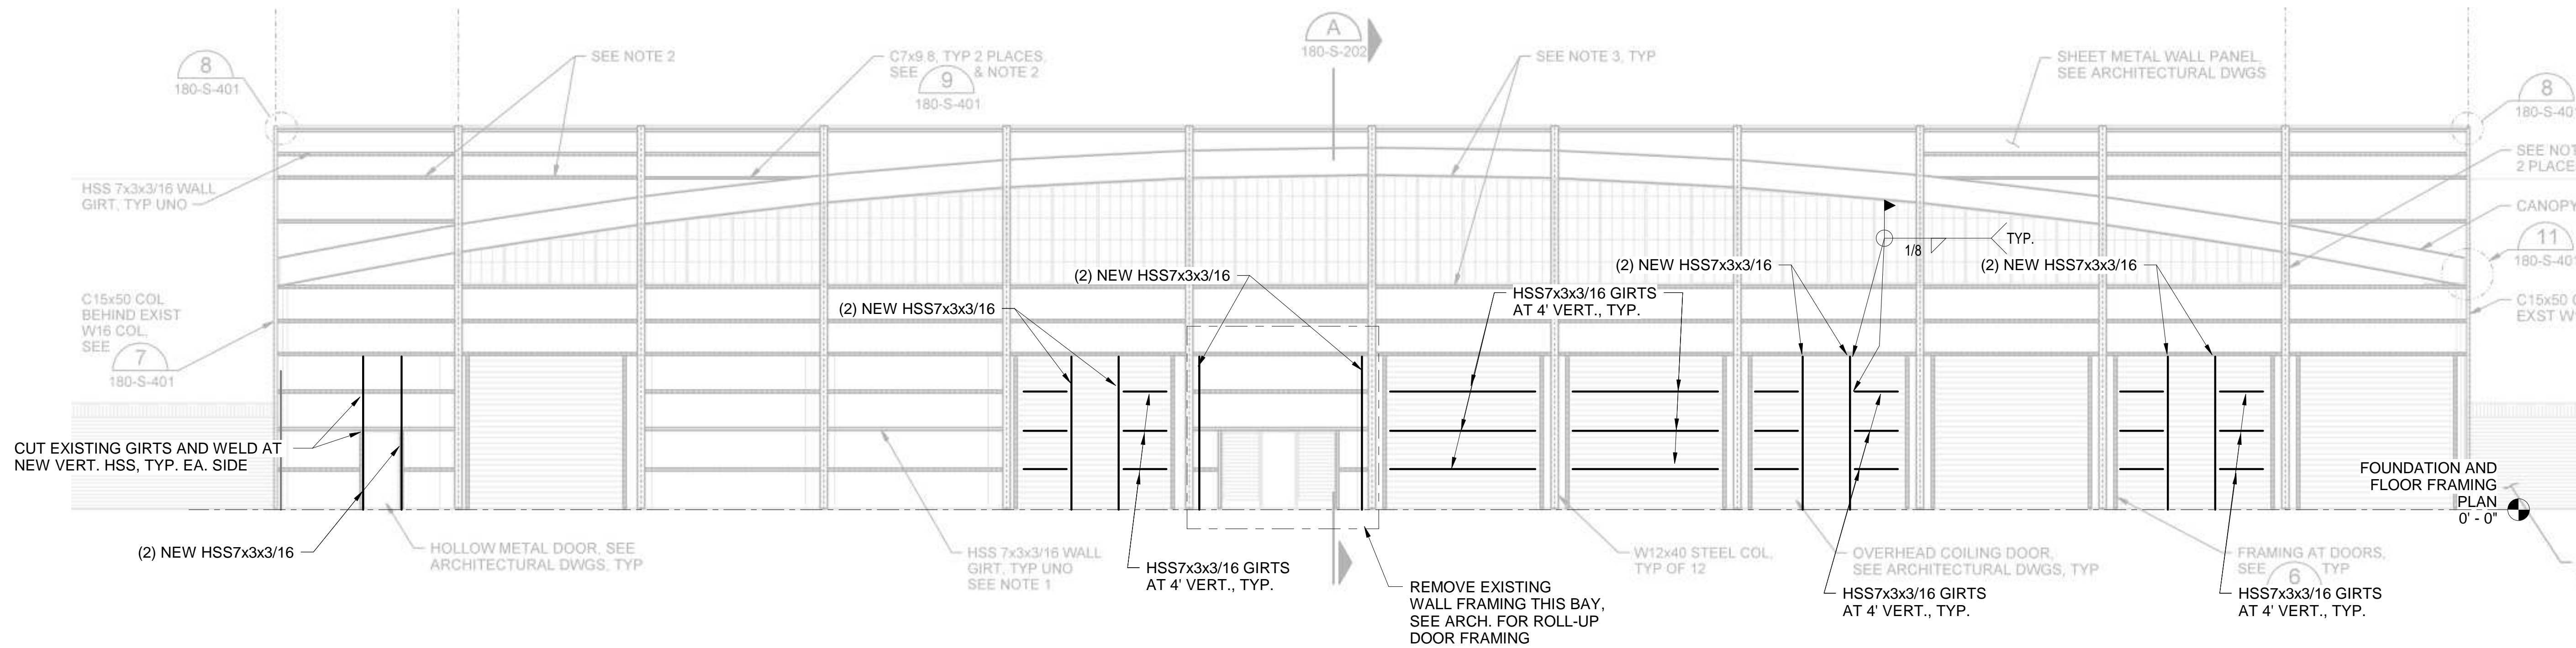


SOUTH WALL FRAMING ELEVATION
1/8" = 1'-0"


NOTE: COORDINATE ALL DIMENSIONS WITH ARCHITECT. CONTRACTOR SHALL VERIFY ALL EXISTING CONDITIONS. NOTIFY THE ARCHITECT AND ENGINEER IMMEDIATELY IF ANY DISCREPANCIES ARE FOUND.

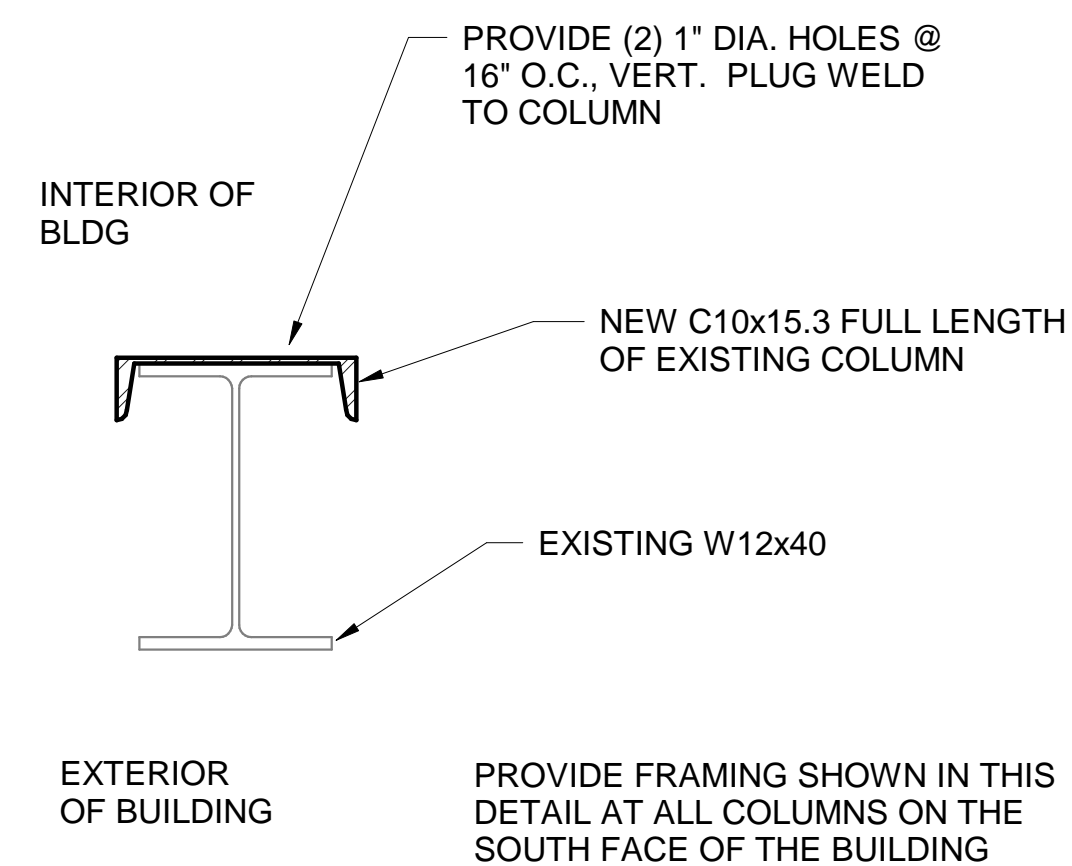

TYP. W12x40 COLUMN REINF.
1 1/2" = 1'-0"

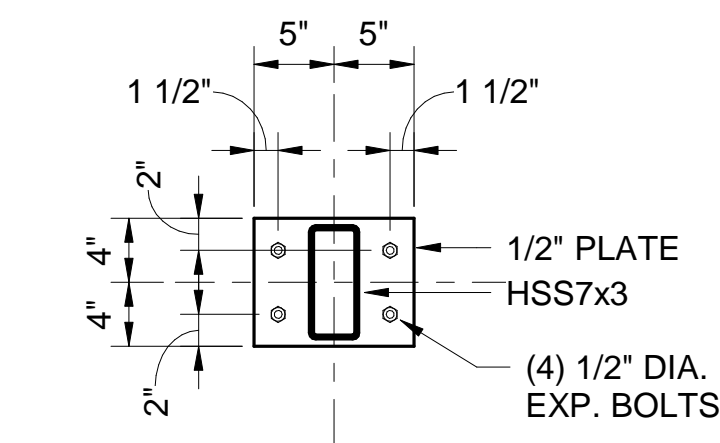

TYP. HSS7x3 BASE PLATE
1" = 1'-0"

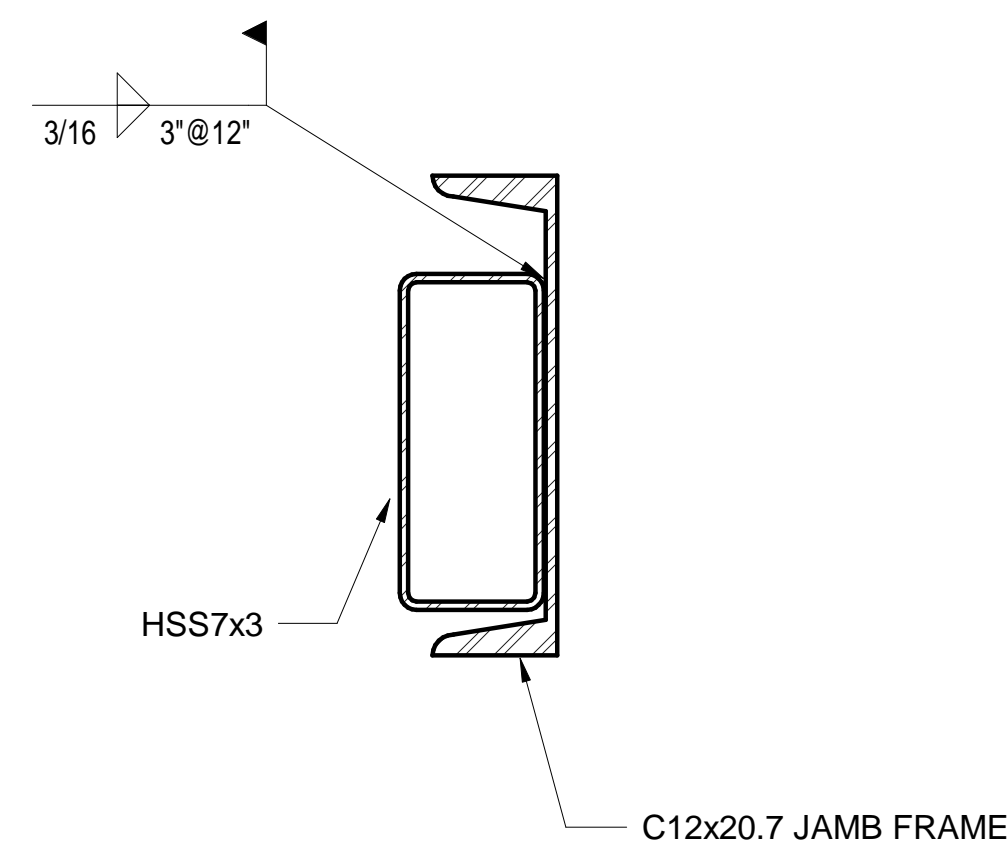

JAMB DETAIL
3" = 1'-0"


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NO.	REMARKS	DATE




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SOUTH WALL FRAMING PLAN AND DETAILS



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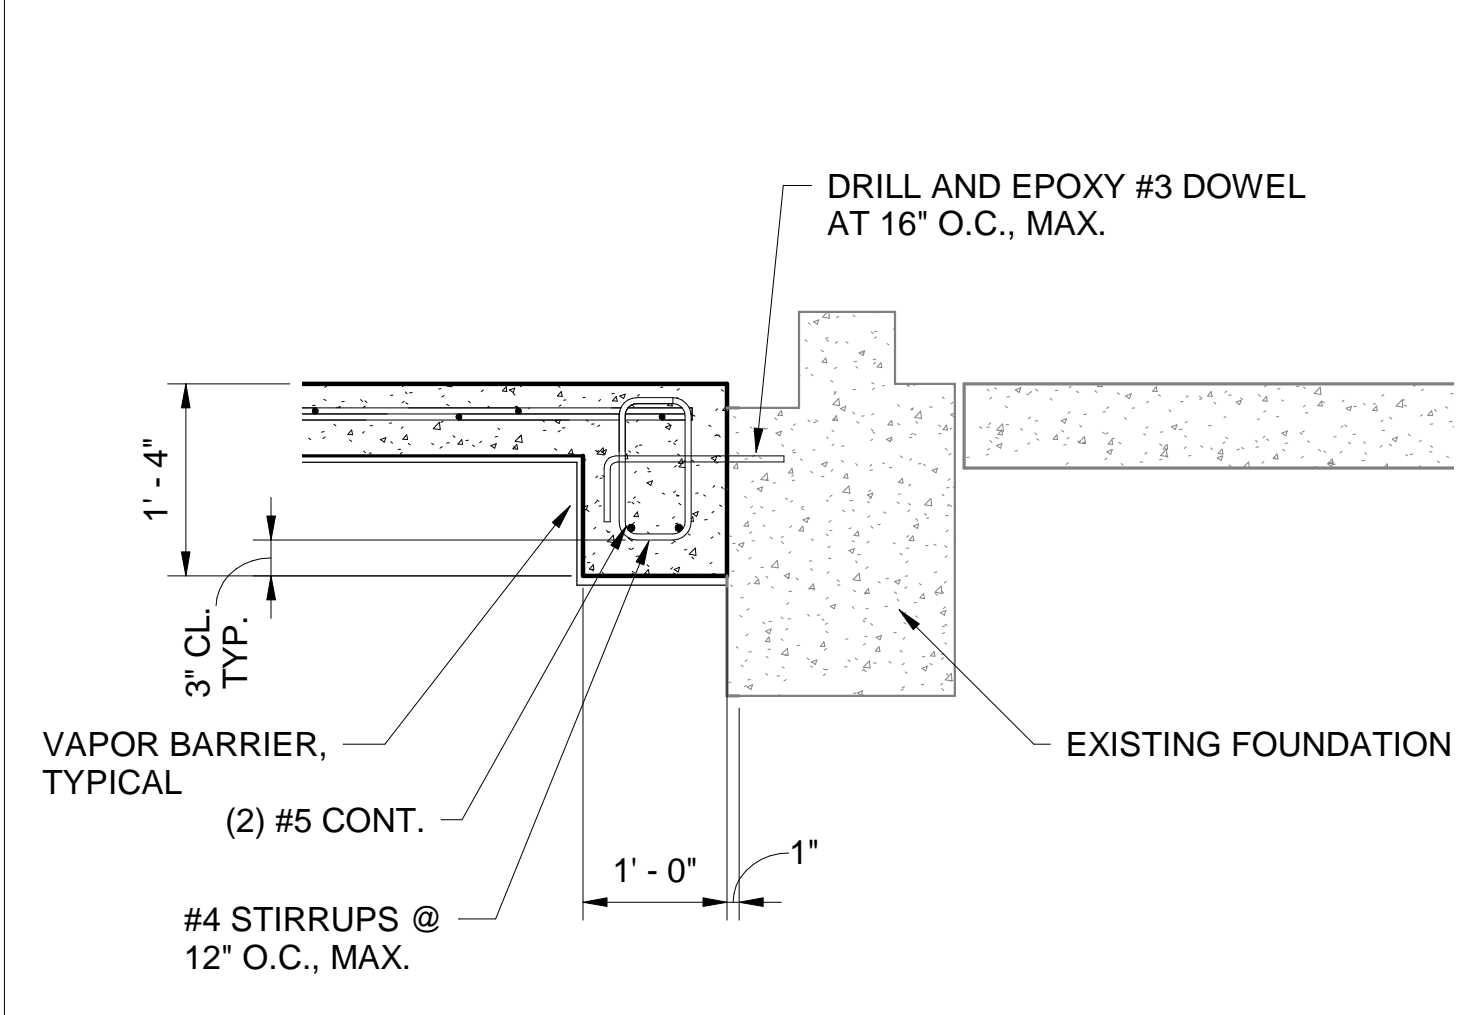
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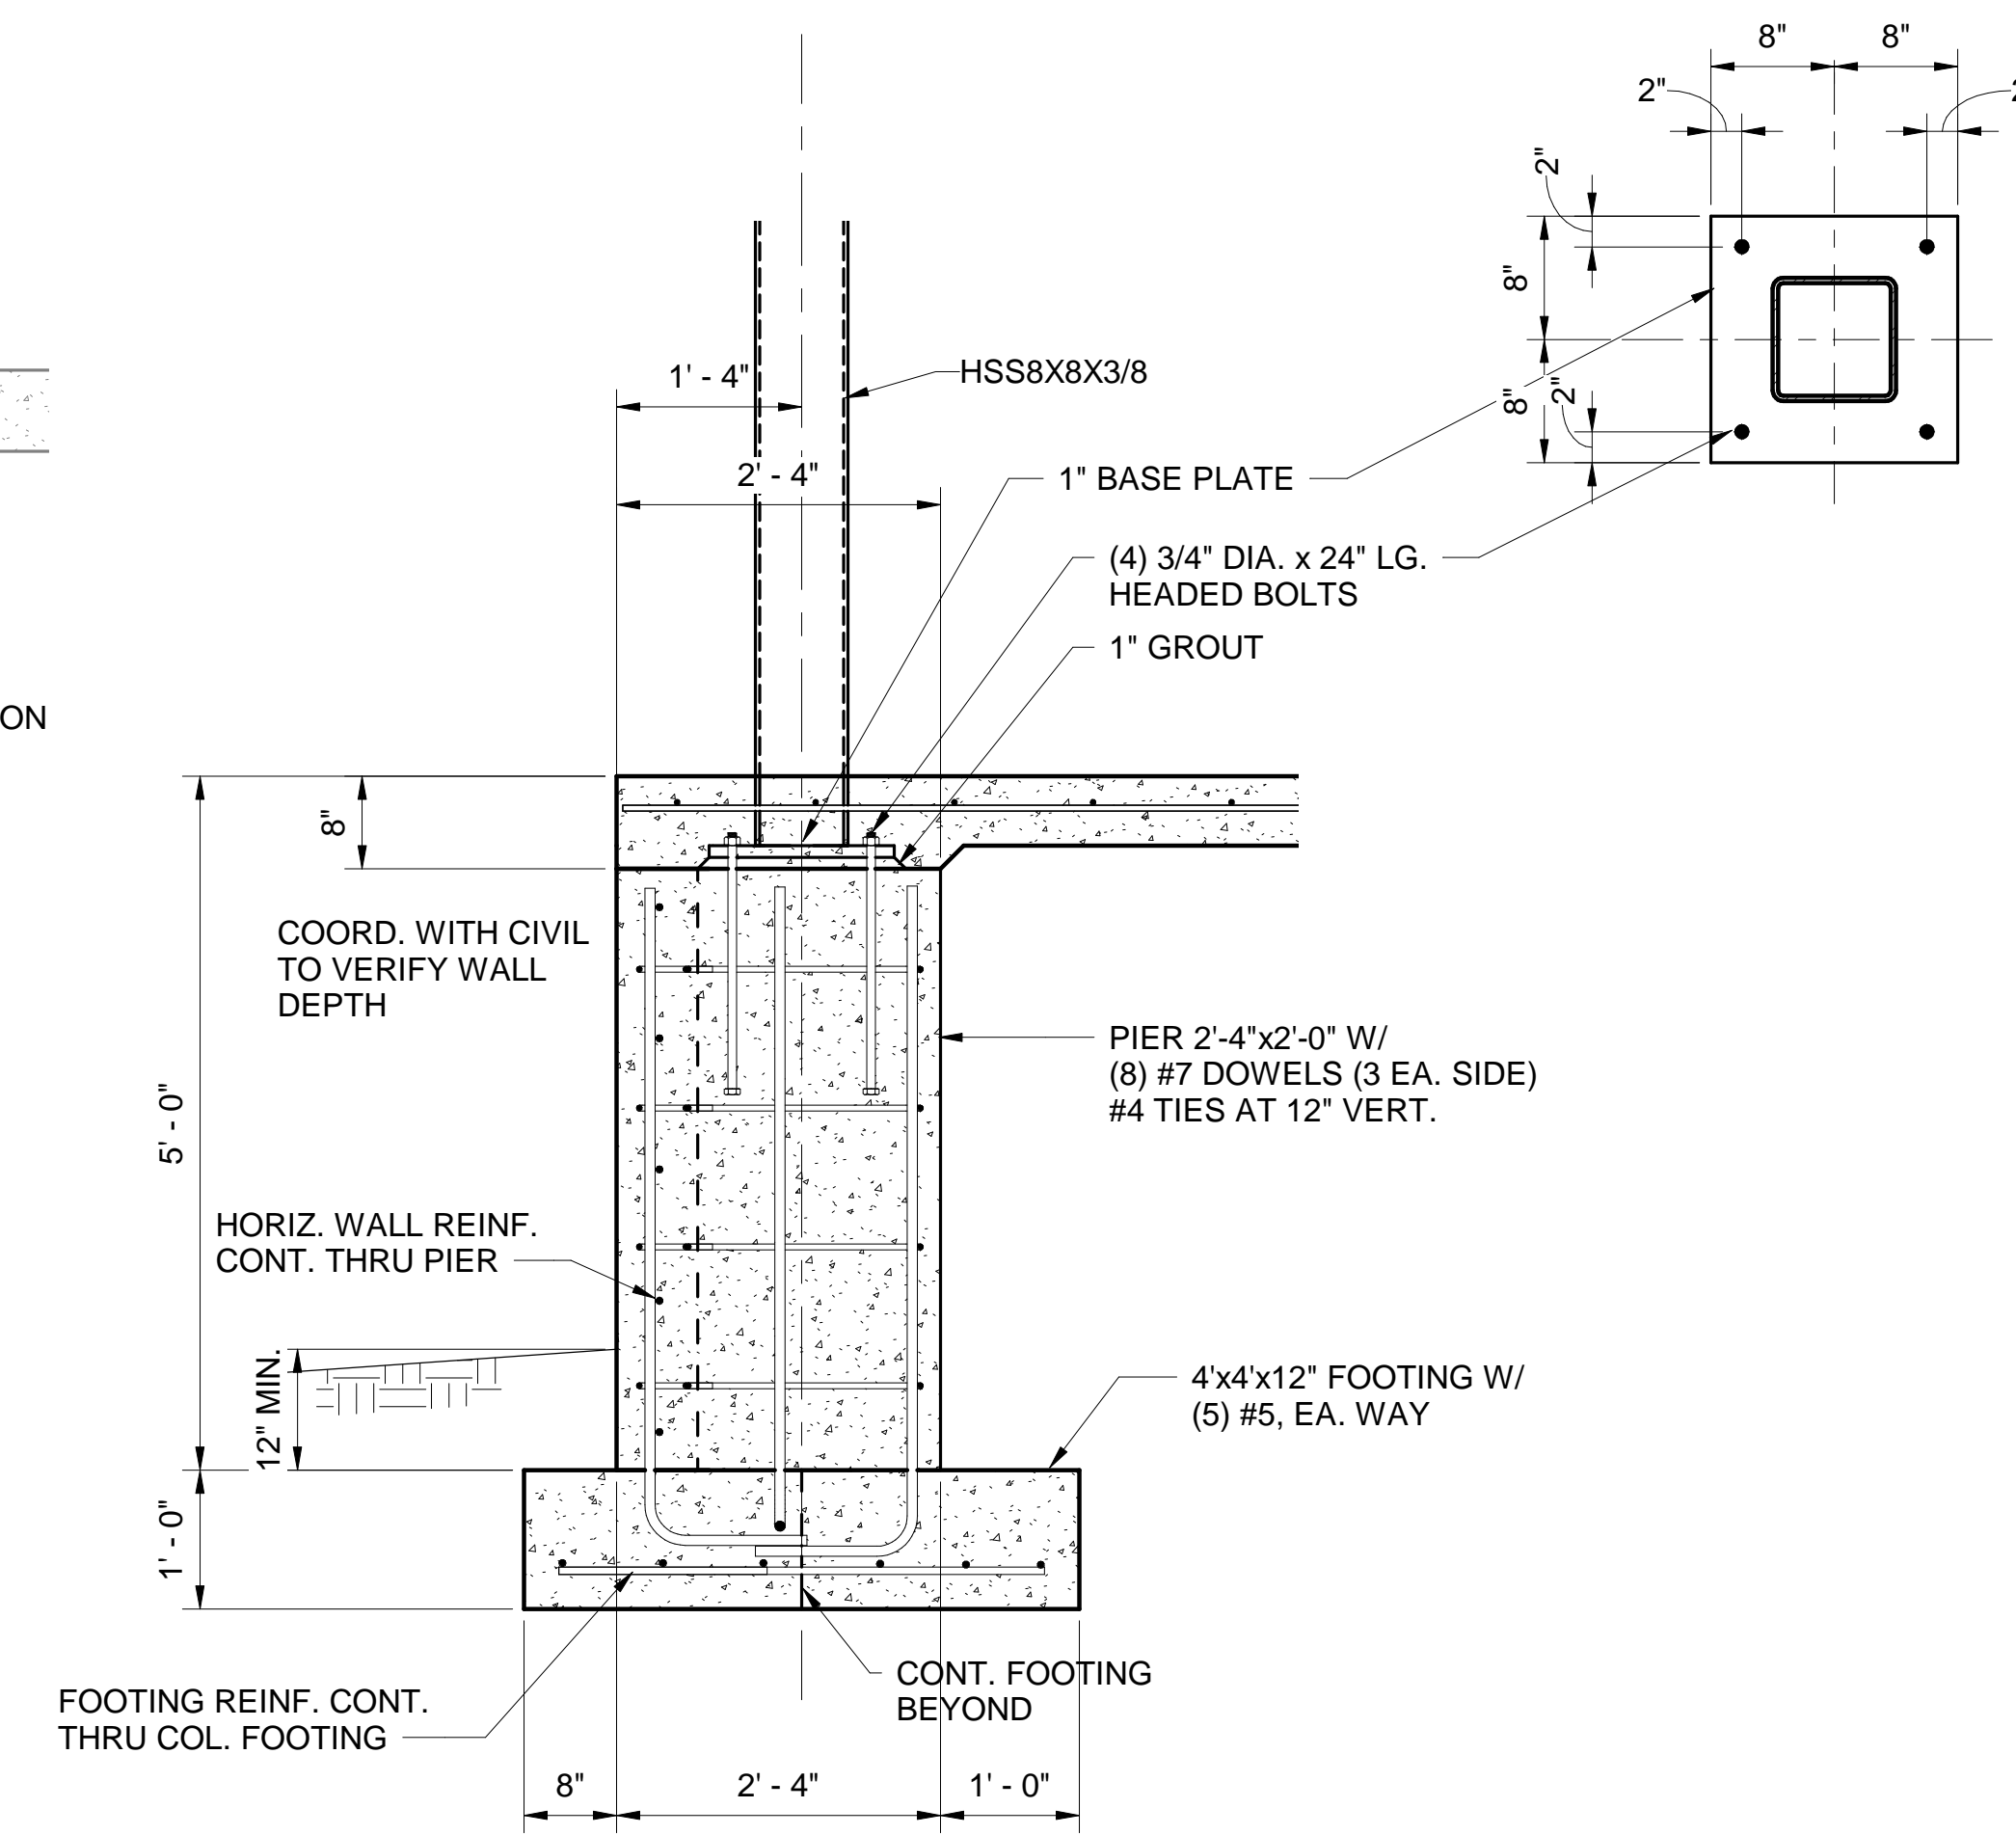
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FOUNDATION DETAILS

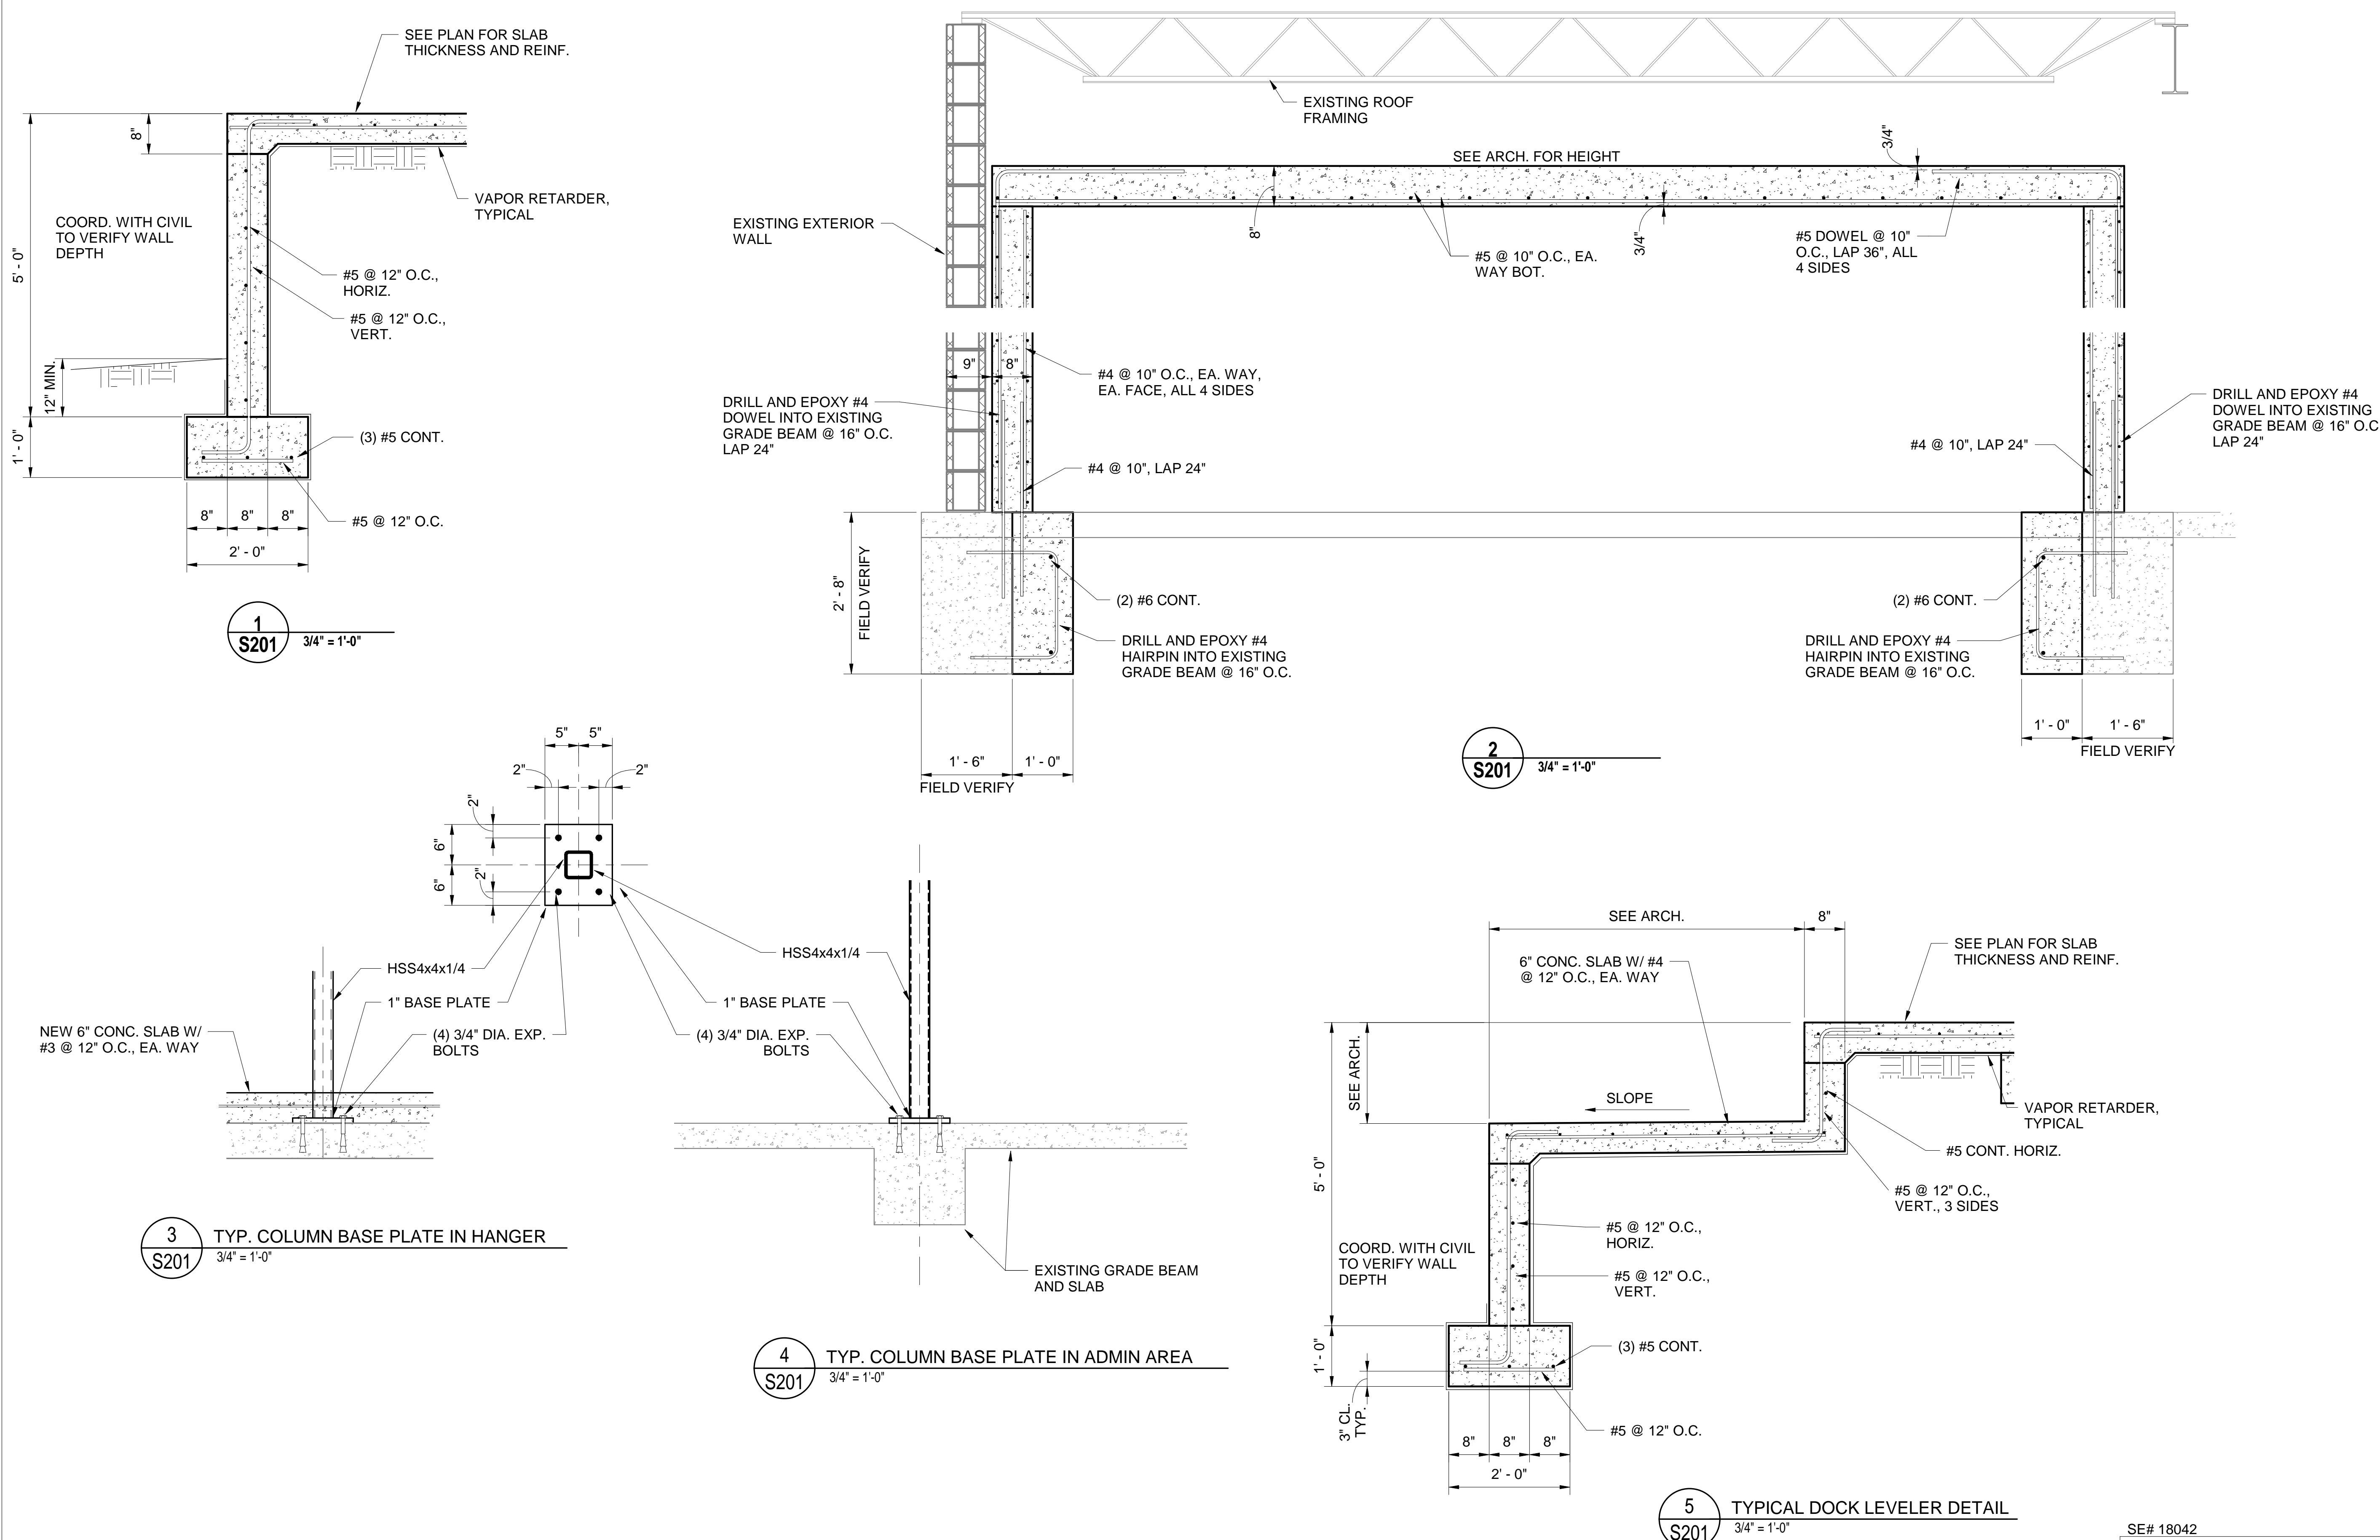
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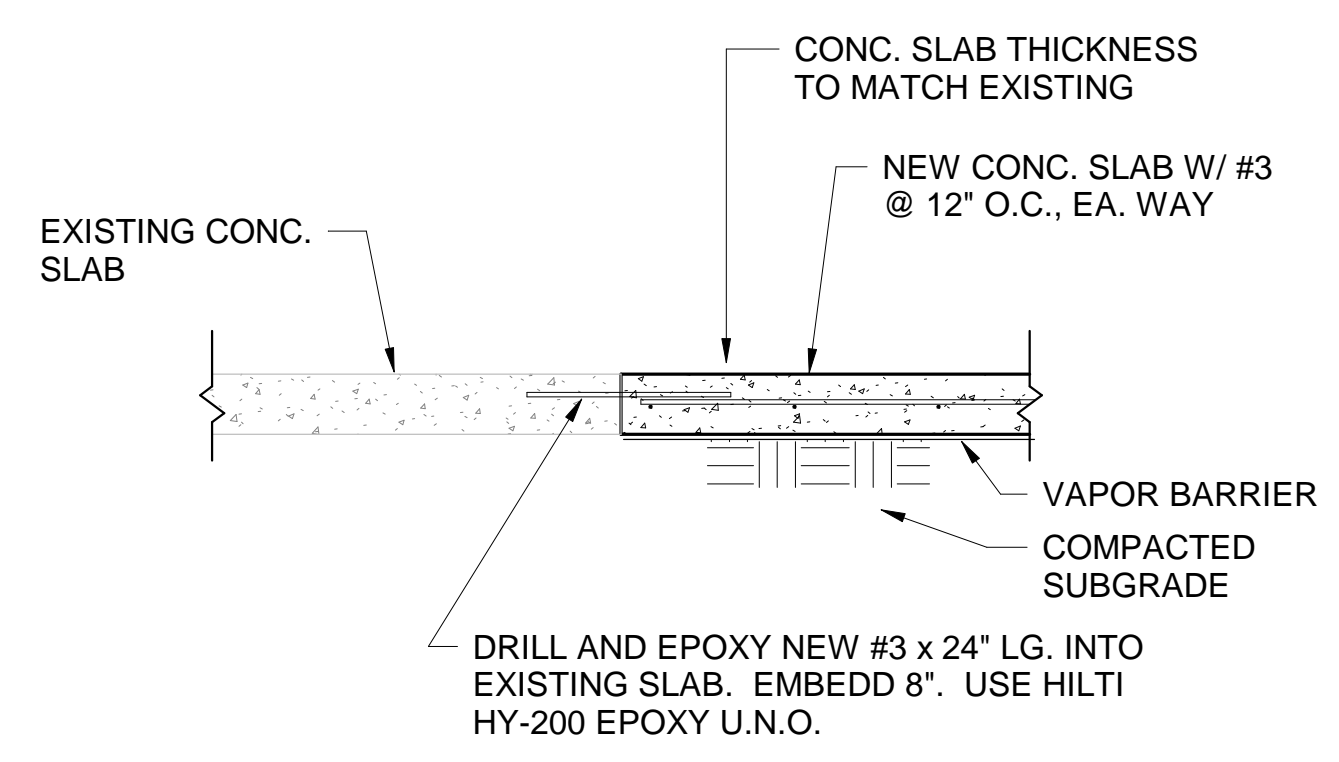
1
S202 3/4" = 1'-0"

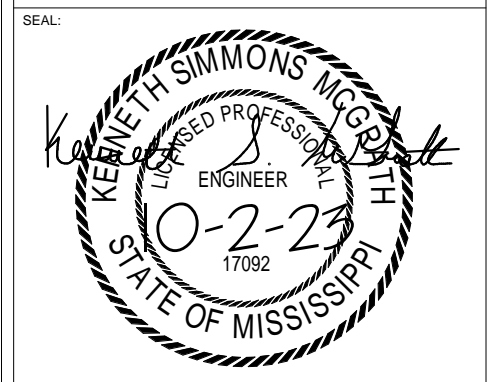

2
S202 3/4" = 1'-0"




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S202 1" = 1'-0"

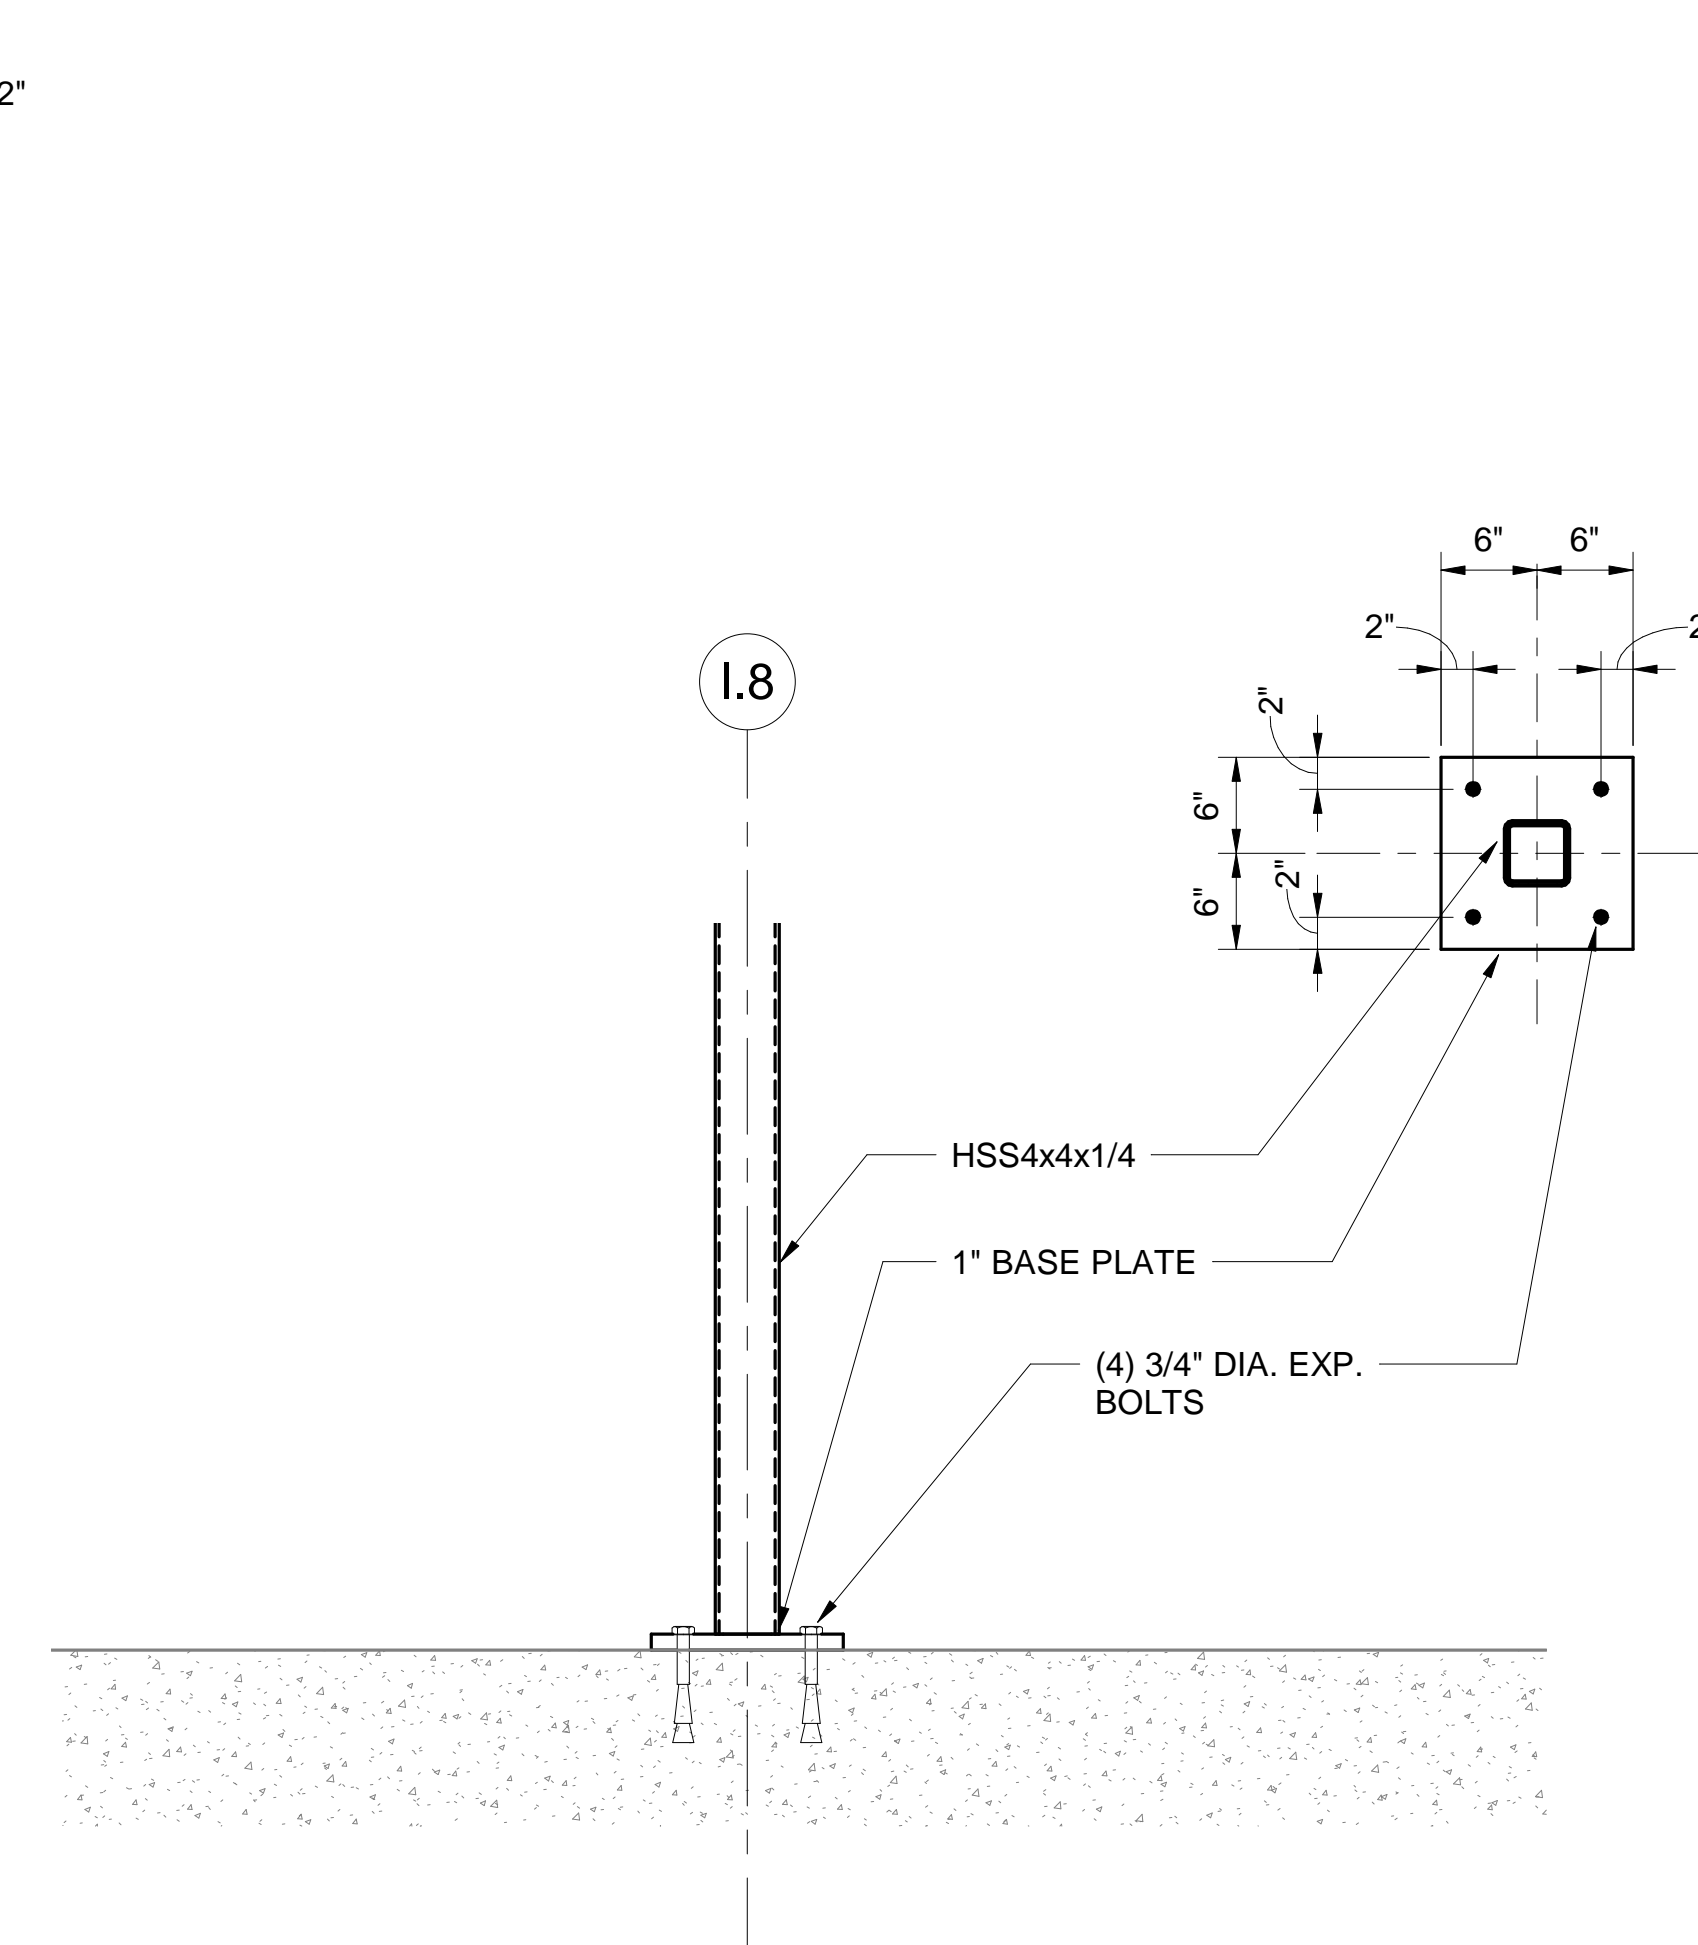

TYPICAL SLAB INFILL DETAIL
3/4" = 1'-0"

RENOVATE BASE SUPPLY
BUILDING B180
MS AIR NATIONAL GUARD
172ND AIRLIFT WING
PROJECT# LRXQ 172402


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NO.	REMARKS	DATE

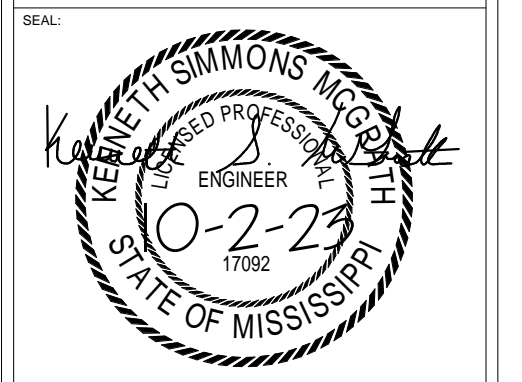


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FOUNDATION
DETAILS

RENOVATE BASE SUPPLY WAREHOUSE B180
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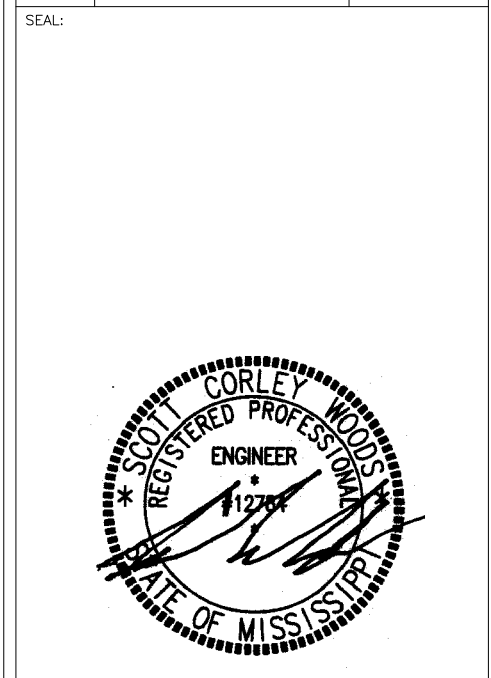
- KEYED H.V.A.C. DEMOLITION NOTES:**
- ① INDICATES EXISTING GAS-FIRED FURNACE TO BE REMOVED IN ITS ENTIRETY.
 - ② INDICATES EXISTING LOW PRESSURE SUPPLY AIR DUCT INCLUDING REGISTERS AND DIFFUSERS TO BE REMOVED IN THEIR ENTIRETY.
 - ③ INDICATES EXISTING ROOF MOUNTED EXHAUST FAN TO BE REMOVED IN ITS ENTIRETY.
 - ④ INDICATES EXISTING EXHAUST AIR DUCT AND RELATED GRILLES TO BE REMOVED.
 - ⑤ INDICATES EXISTING RETURN AIR DUCT AND RELATED GRILLES TO BE REMOVED.
 - ⑥ INDICATES EXISTING SIDEWALL EXHAUST FAN AND RELATED DUCT AND GRILLE, TO BE REMOVED.
 - ⑦ INDICATES EXISTING GAS-FIRED UNIT HEATER TO BE REMOVED.
 - ⑧ INDICATES EXISTING CONDENSING UNITS TO BE REMOVED.
 - ⑨ INDICATES EXISTING WALL MOUNTED MINI-SPLIT UNIT AND MATCHING CONDENSING UNIT TO BE REMOVED IN ITS ENTIRETY.

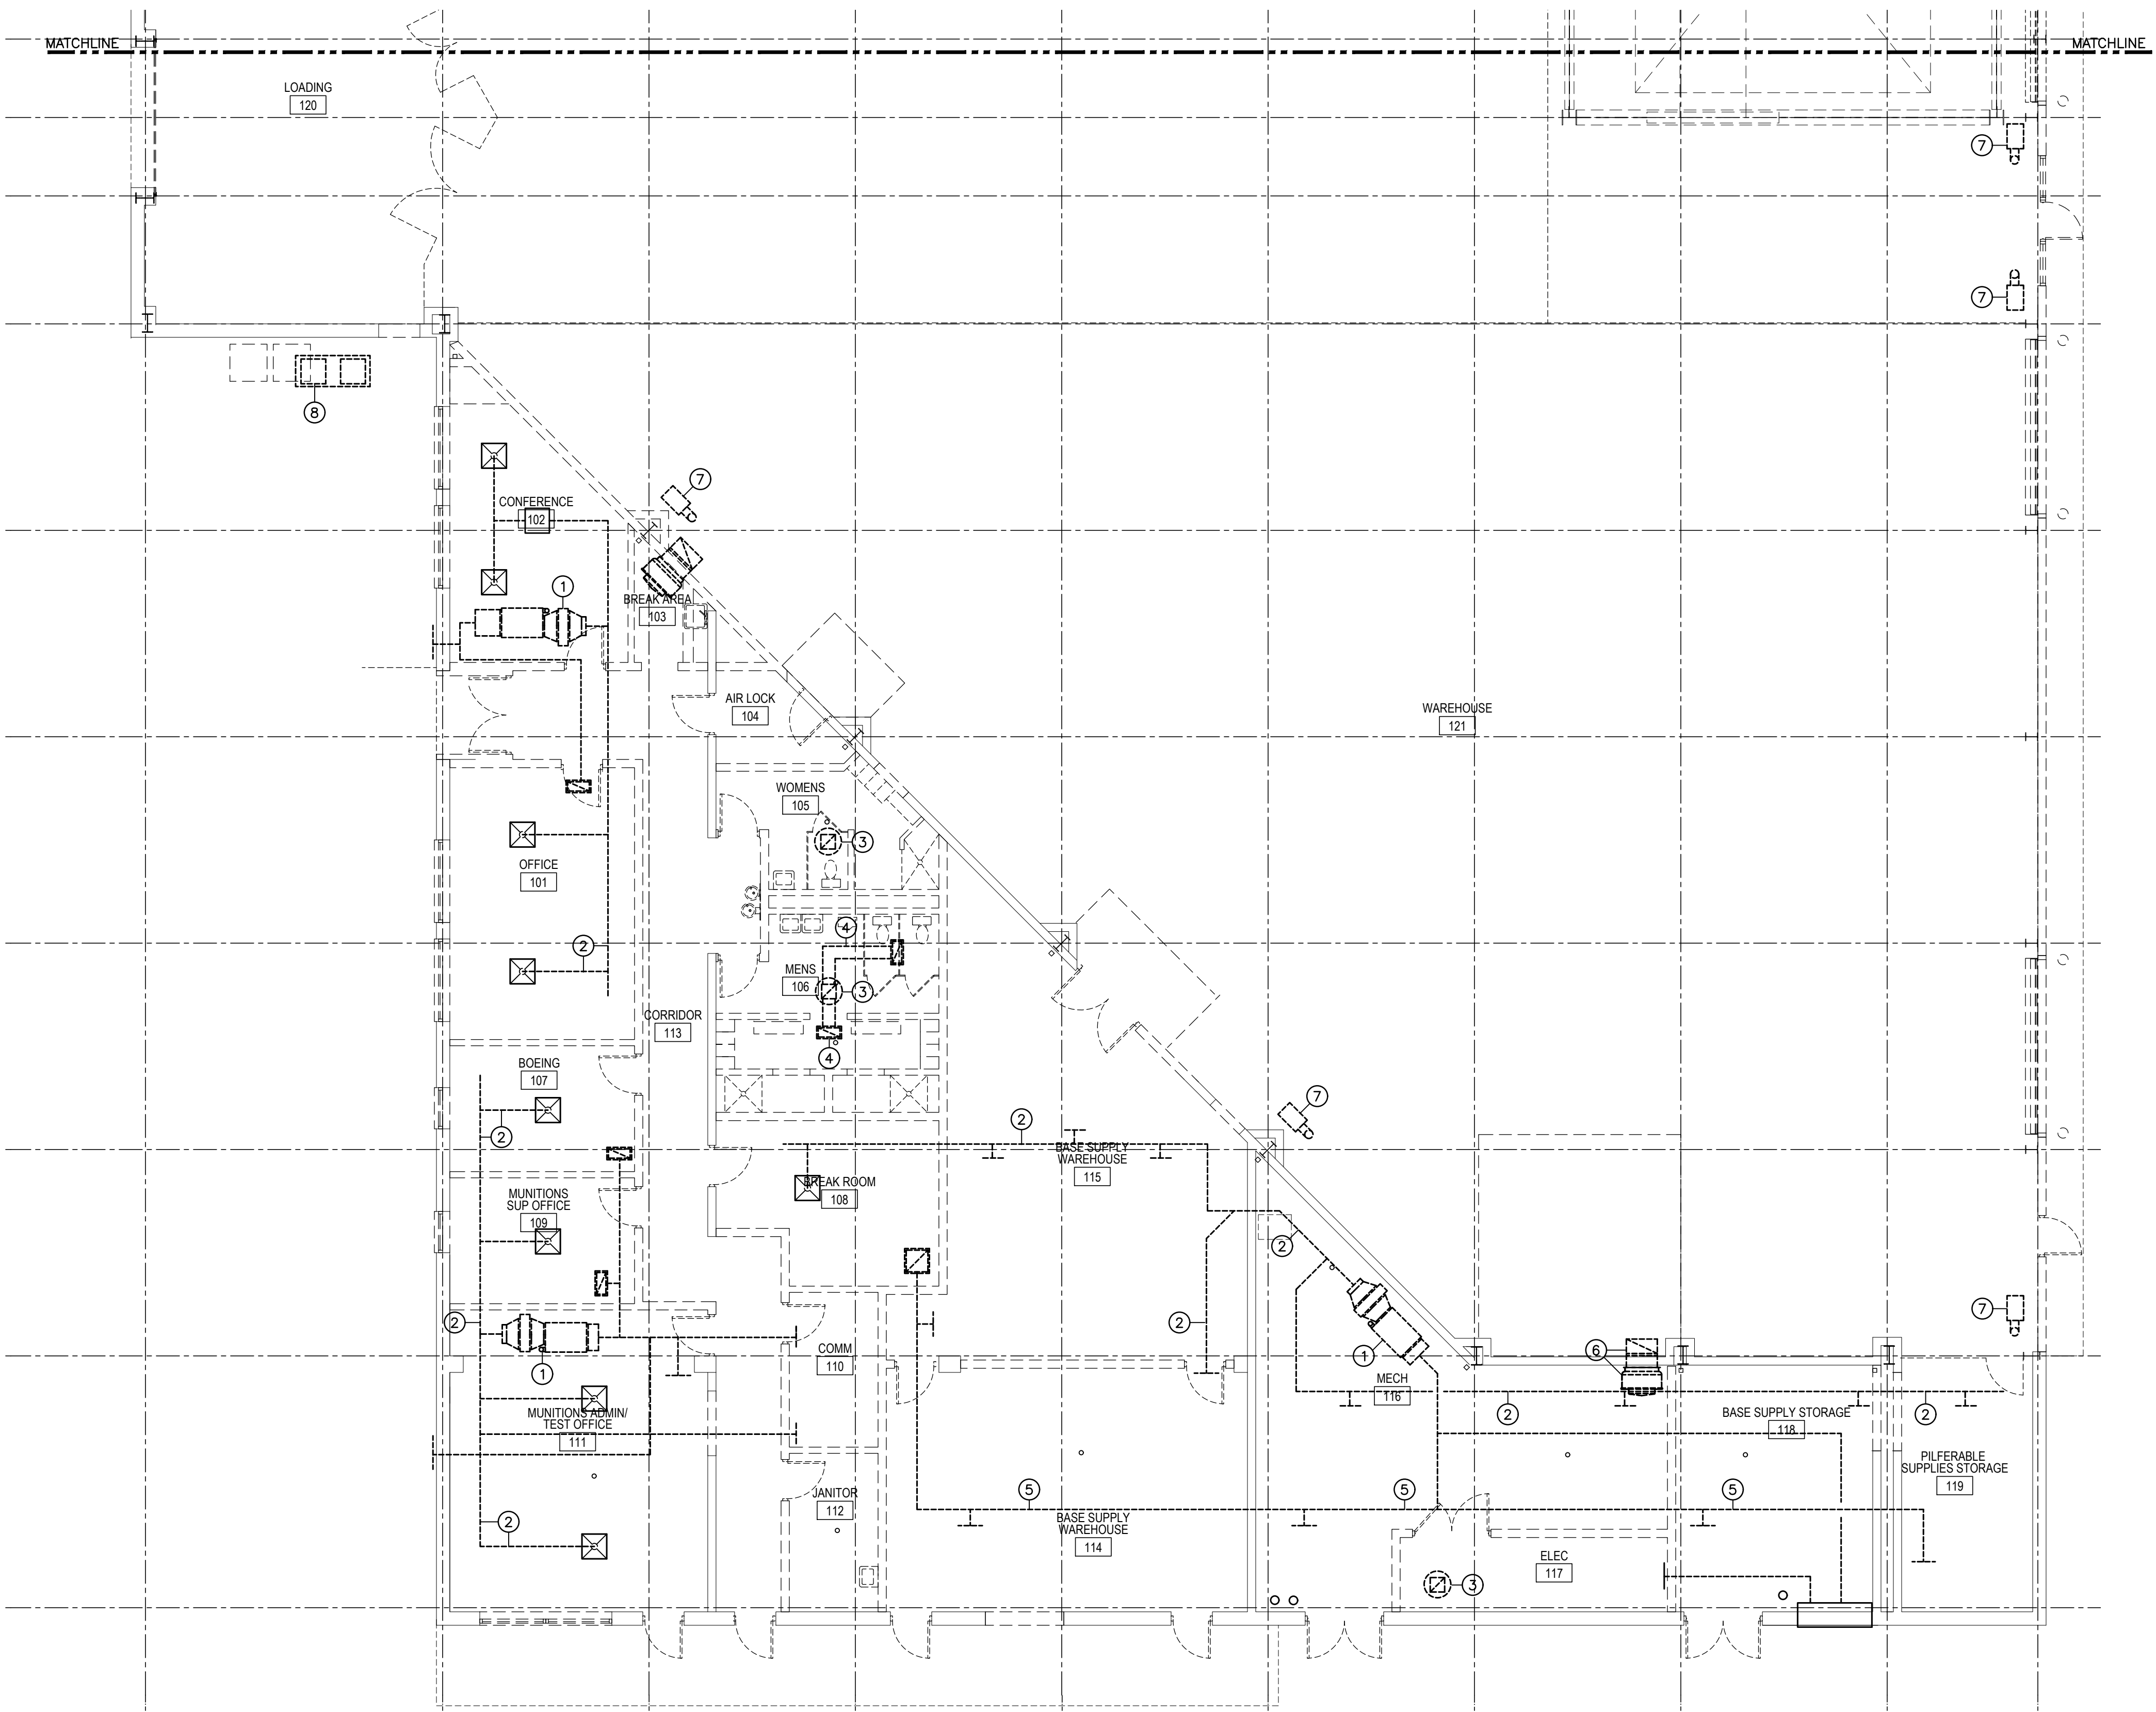

PARTIAL FLOOR PLAN - H.V.A.C. DEMOLITION
 SCALE: 1/8"=1'-0"
 NORTH

DRAWING REVISIONS

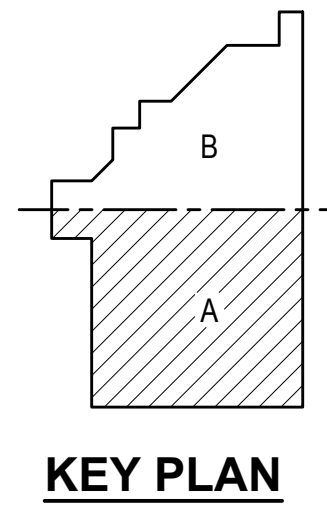NO.	REMARKS	DATE




SCWA #18-052
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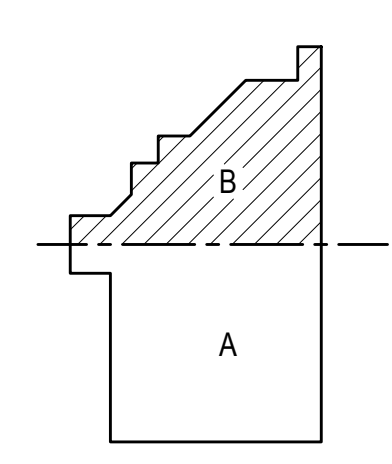
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FLOOR PLAN/HVAC DEMO
 SHEET NUMBER **M1.1**

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- GENERAL NOTES:
- A. INSTALLATION
 1. ALL PIPING OR DUCTS IN FINISHED ROOMS OR SPACES SHALL BE CONCEALED IN FURRED CHASES OR SUSPENDED CEILINGS.
 2. THERMOSTATS SHALL BE LOCATED 5'-0" ABOVE FLOOR AND SHALL CLEAR ALL EQUIPMENT. THERMOSTATS LOCATED NEXT TO DOORS SHALL BE LOCATED ON LATCH SIDE OF DOOR.
 3. COORDINATE DIFFUSER, GRILLE, AND REGISTER LOCATIONS WITH REFLECTED CEILING PLAN.
 4. THE CONTRACTOR SHALL EXERCISE EXTREME CARE IN THE COORDINATION OF WORK OF ALL TRADES TO ASSURE PROPER INSTALLATION AND CLEARANCES. DRAWINGS ARE ESSENTIALLY DIAGRAMMATICAL AND THEREFORE CONTRACTOR SHOULD PLAN EXACT ROUTING OF DUCT AND PIPE BASED ON FIELD CONDITIONS. PROVIDE ADDITIONAL TRANSITIONS AND OFFSETS AS NECESSARY (AT NO ADDITIONAL COST TO OWNER) TO COMPLETE INSTALLATION AND MAINTAIN REQUIRED CEILING HEIGHTS.
 5. ACCESS PANELS IN DUCTWORK AND NON-ACCESSIBLE CEILINGS SHALL BE PROVIDED FOR OPERATION AND MAINTENANCE OF ALL BOXES, COILS, VALVES, TRAPS, DAMPERS, CLEANOUTS, CONTROLS, ETC. PROVIDE MINIMUM 24" X 24" CEILING ACCESS PANEL FOR VAV BOXES AND 12" X 12" FOR DAMPERS. COORDINATE EXACT PLACEMENT OF ACCESS PANELS AND EQUIPMENT SO THAT REASONABLE MAINTENANCE SPACE IS AVAILABLE.
 6. CONTRACTOR SHALL COORDINATE ALL OPENINGS IN ROOF TO CONFORM WITH DIMENSIONS OF EQUIPMENT PURCHASED. DUCTS THROUGH ROOF TO FANS AND HVAC EQUIPMENT SHALL BE TRANSITIONED TO COORDINATE WITH EQUIPMENT CONNECTION SIZES AND ROOF OPENING REQUIREMENTS.
 7. INSTALLATION OF ALL EQUIPMENT AND SYSTEMS SHALL BE IN ACCORDANCE WITH STANDARD DETAILS, SECTIONS, AND ELEVATIONS SHOWN ON THE DRAWINGS.
 8. CONTRACTOR SHALL MAINTAIN A CLEAR SERVICE AREA AROUND ALL EQUIPMENT FOR MAINTENANCE SUCH AS, FILTER REMOVAL, MOTOR AND DRIVE ADJUSTMENTS, COIL AND TUBE CLEANING OR REMOVAL.
 9. ALL CONSTRUCTION SHALL BE PER DETAILS AND SPECIFICATIONS OF CONTRACT DOCUMENTS.
 - B. DUCTWORK
 1. ALL DUCT RUNOUTS TO DIFFUSERS, RETURN AIR GRILLES AND EXHAUST GRILLES SHALL BE COMPLETE WITH VOLUME DAMPERS UNLESS NOTED OTHERWISE. DAMPERS MAY BE OMITTED IN DUCT RUNOUTS FROM BOXES SERVING SINGLE DIFFUSER. LOCATE DAMPERS SO THEY ARE ACCESSIBLE FROM LAY-IN CEILING OR ACCESS DOORS.
 2. ROUND SUPPLY RUNOUTS TO DIFFUSERS SHALL BE HARD METAL TO WITHIN 5'-0" DEVELOPED LENGTH FROM DIFFUSER. MAXIMUM 5'-0" OF FLEXIBLE DUCT MAY BE USED FOR FINAL CONNECTION TO DIFFUSER.
 3. DUCT TRANSITIONS SHALL BE PROVIDED AS REQUIRED FROM ALL EQUIPMENT CONNECTS TO DUCT SIZES INDICATED ON DRAWINGS.
 4. PROVIDE EASED INLET RECTANGULAR TO ROUND TAPS AT DUCT TAPS IF ROUND DUCT SIZE IS TOO LARGE FOR BELLMOUTH TAP TO TRUNK DUCT.




KEY PLAN

FIRST FLOOR PLAN - PART B - HVAC
 SCALE: 1/8"=1'-0"
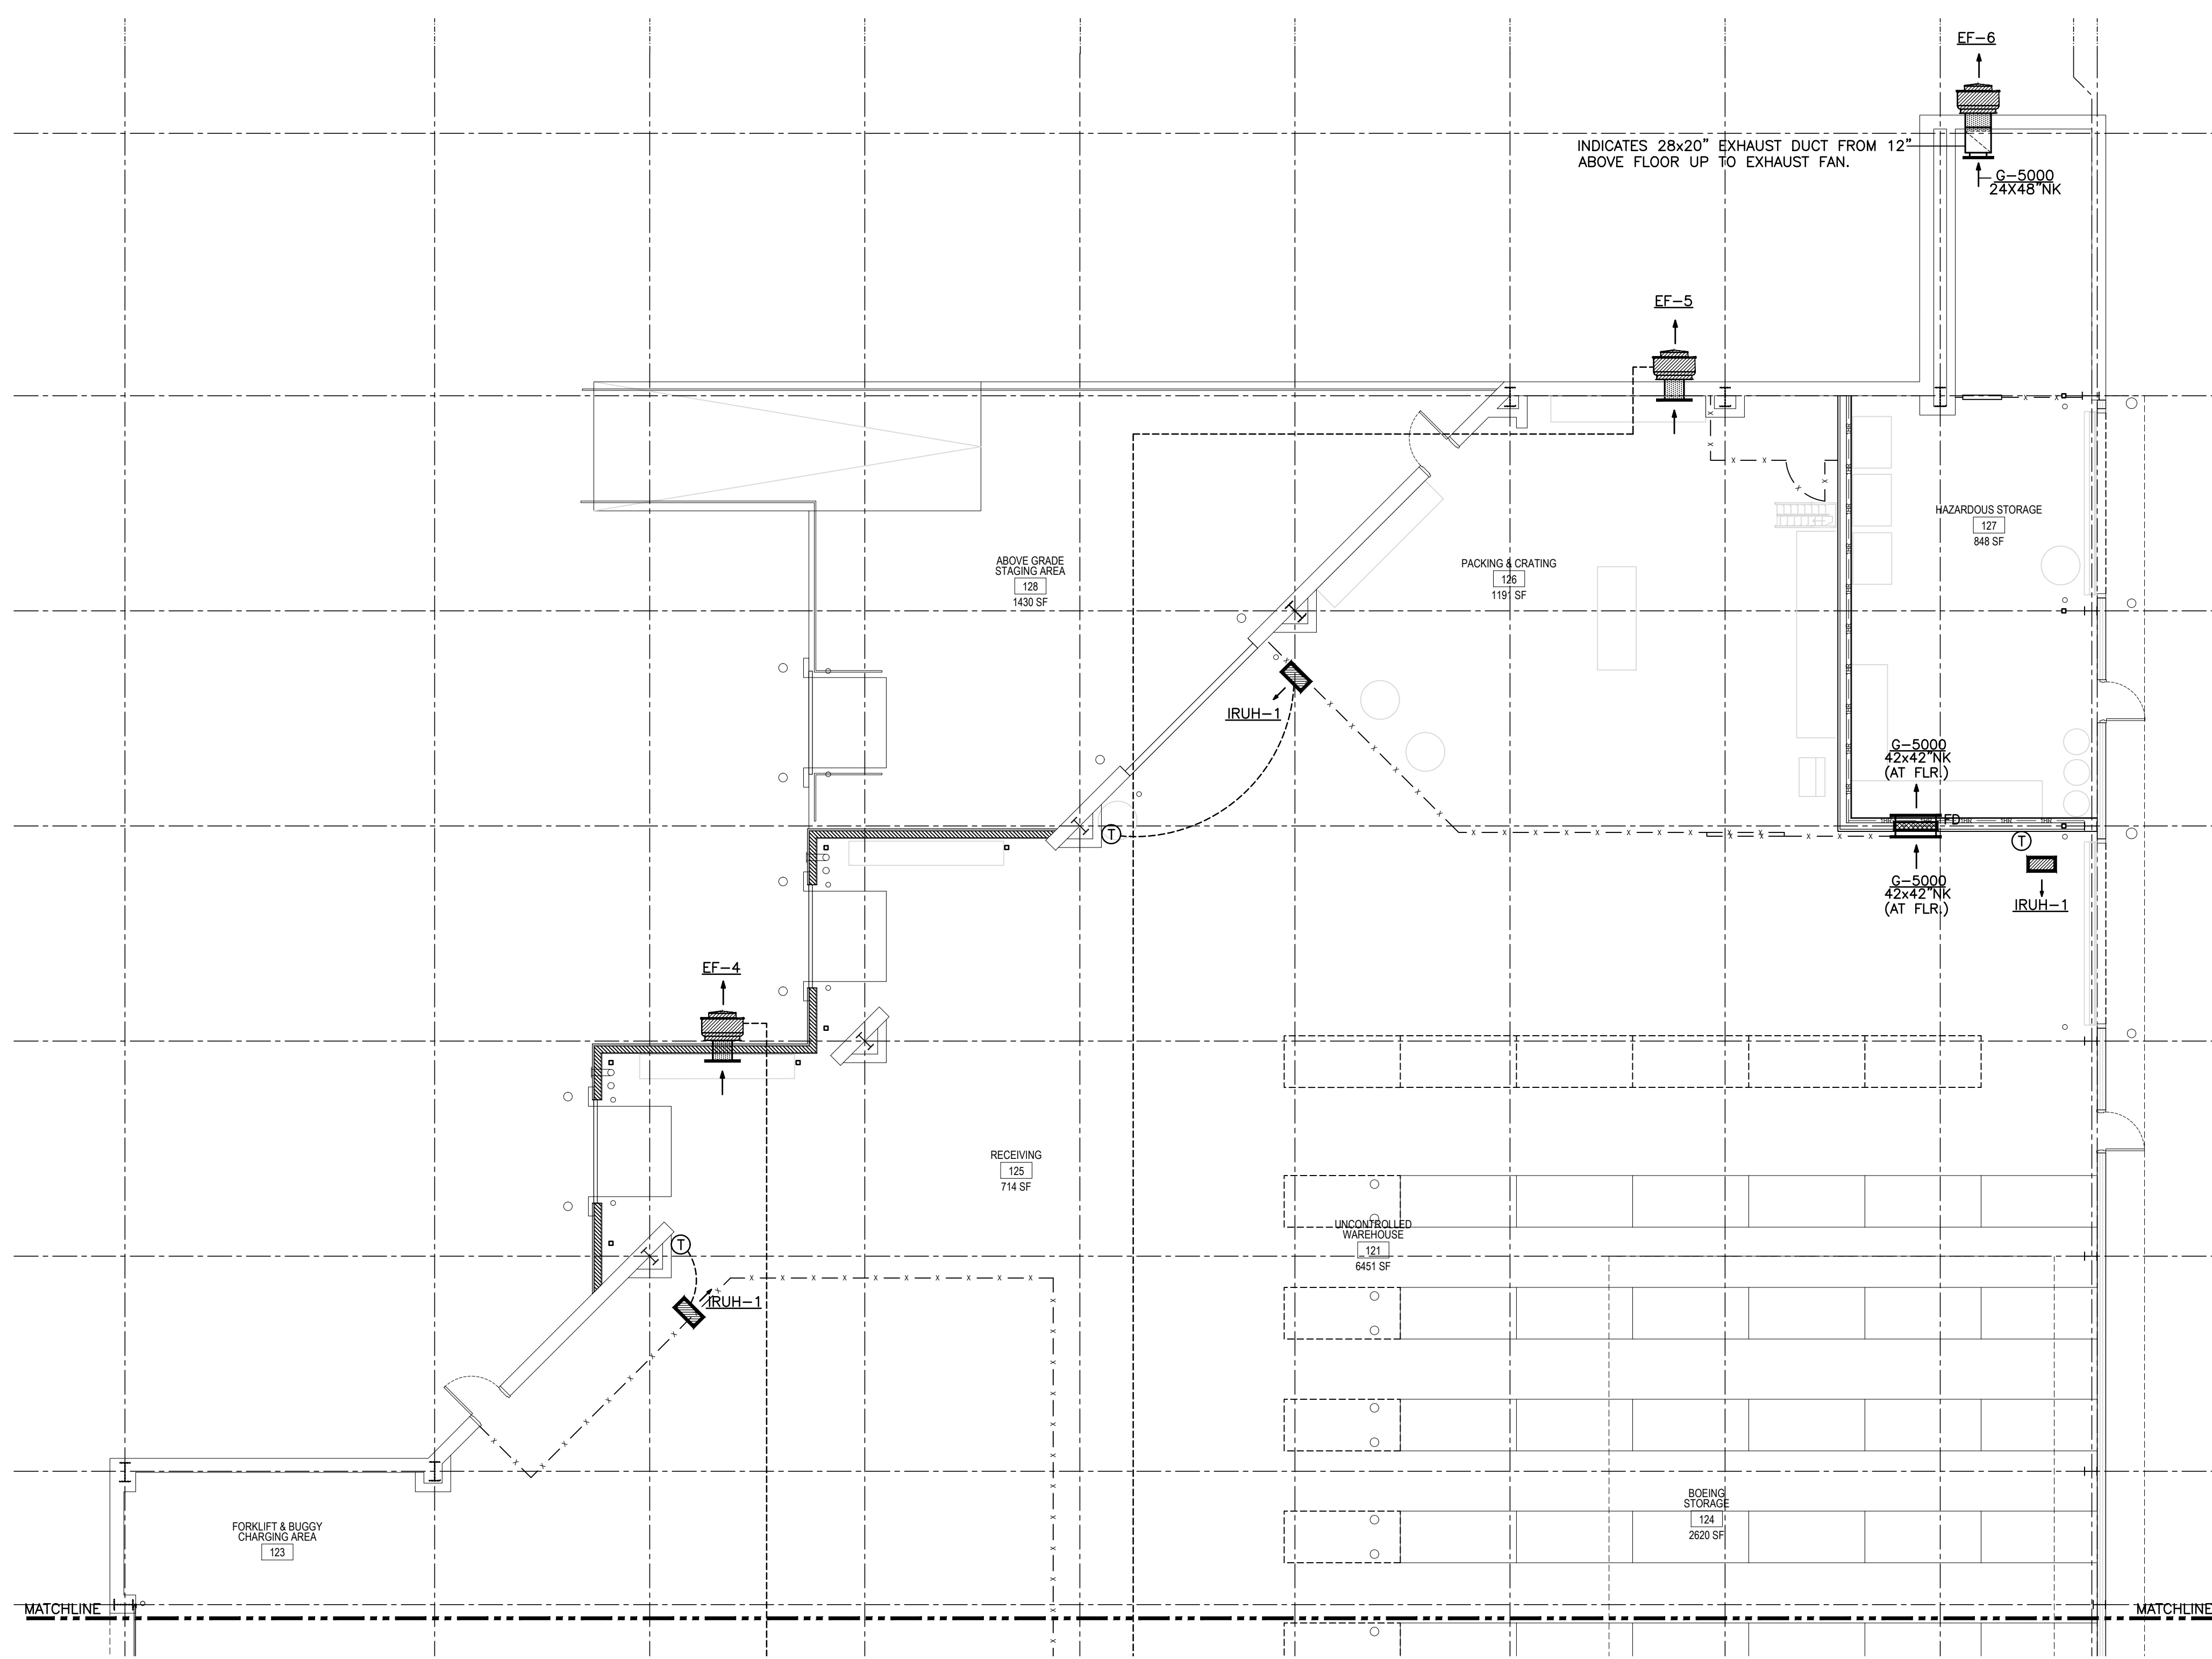
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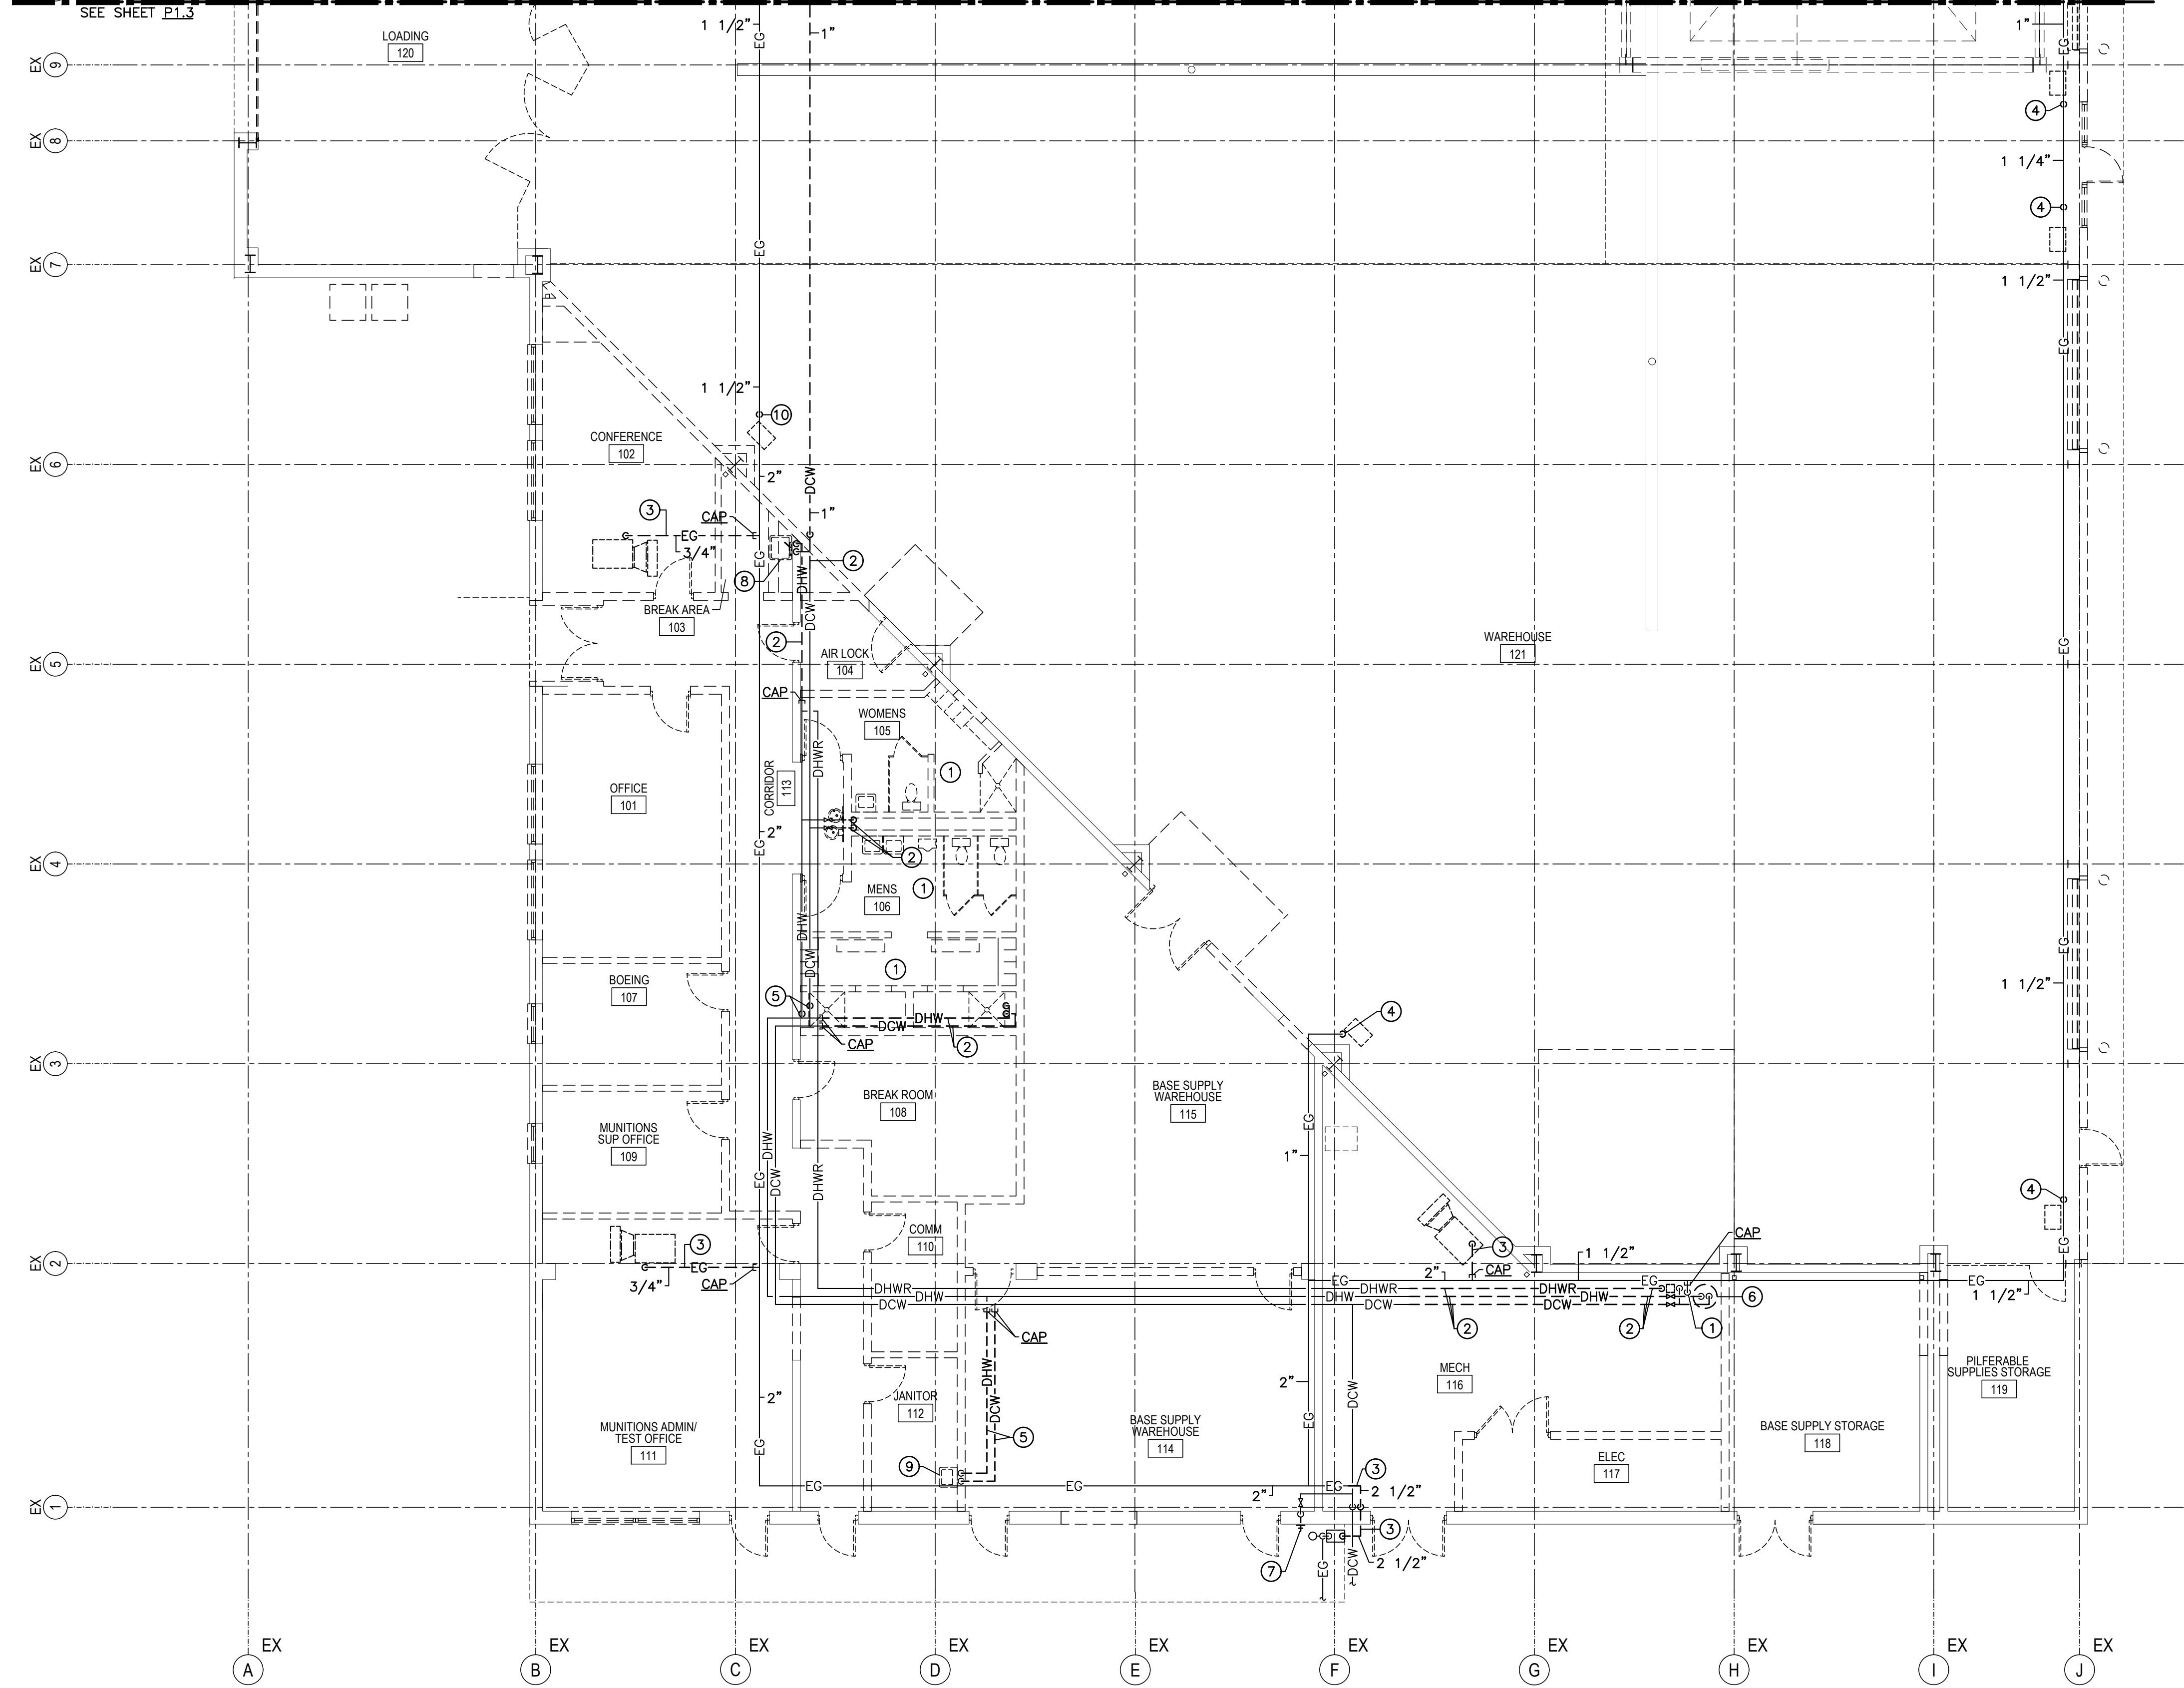


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FLOOR PLAN/HVAC
 SHEET NUMBER
M2.2

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FOR CONTINUATION
SEE SHEET P1.3


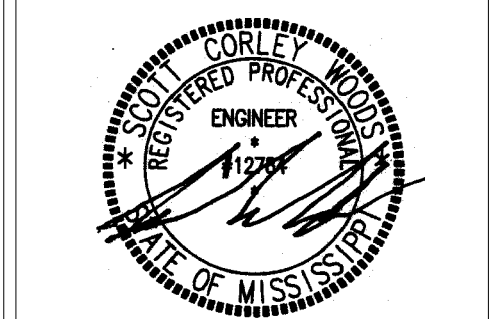


KEYED DEMO. NOTES

- ① CONTRACTOR SHALL REMOVE ALL THE PLUMBING FIXTURES IN THIS TOILET, INCLUDING THE EXISTING DOMESTIC WATER PIPING.
- ② INDICATES EXISTING DOMESTIC WATER LINE TO BE REMOVED.
- ③ INDICATES EXISTING GAS LINE TO BE REMOVED.
- ④ INDICATES THE EXISTING GAS DROP TO BE REMOVED.
- ⑤ INDICATES EXISTING DOMESTIC WATER PIPING TO BE REMOVED AND CAPPED AT THE EXISTING MAIN.
- ⑥ INDICATES THE EXISTING WATER HEATER AND DOMESTIC WATER PUMP TO BE REMOVED IN THEIR ENTIRETY, THIS SHALL INCLUDE ALL THE DOMESTIC WATER PIPING AND GAS PIPING SERVING THE WATER HEATER.
- ⑦ INDICATES EXISTING HOSE BIBB TO BE REMOVED.
- ⑧ INDICATES EXISTING SINK TO BE REMOVED IN ITS ENTIRETY.
- ⑨ INDICATES EXISTING SERVICE SINK TO BE REMOVED IN ITS ENTIRETY. THIS SHALL INCLUDE THE EXISTING DOMESTIC WATER PIPING.
- ⑩ INDICATES THE EXISTING GAS DROP TO BE REMOVED AND CAPPED.

GENERAL NOTES

1. FOR ALL NEW WORK AND PIPING SEE SHEET P2.2.

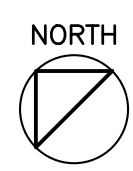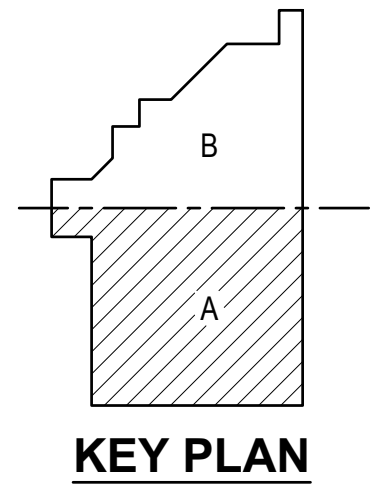

PARTIAL FLOOR PLAN-PART A/DOMESTIC WATER AND GAS DEMOLITION

SCALE: 1/8"=1'-0"




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PROJECT# LRXQ 172402

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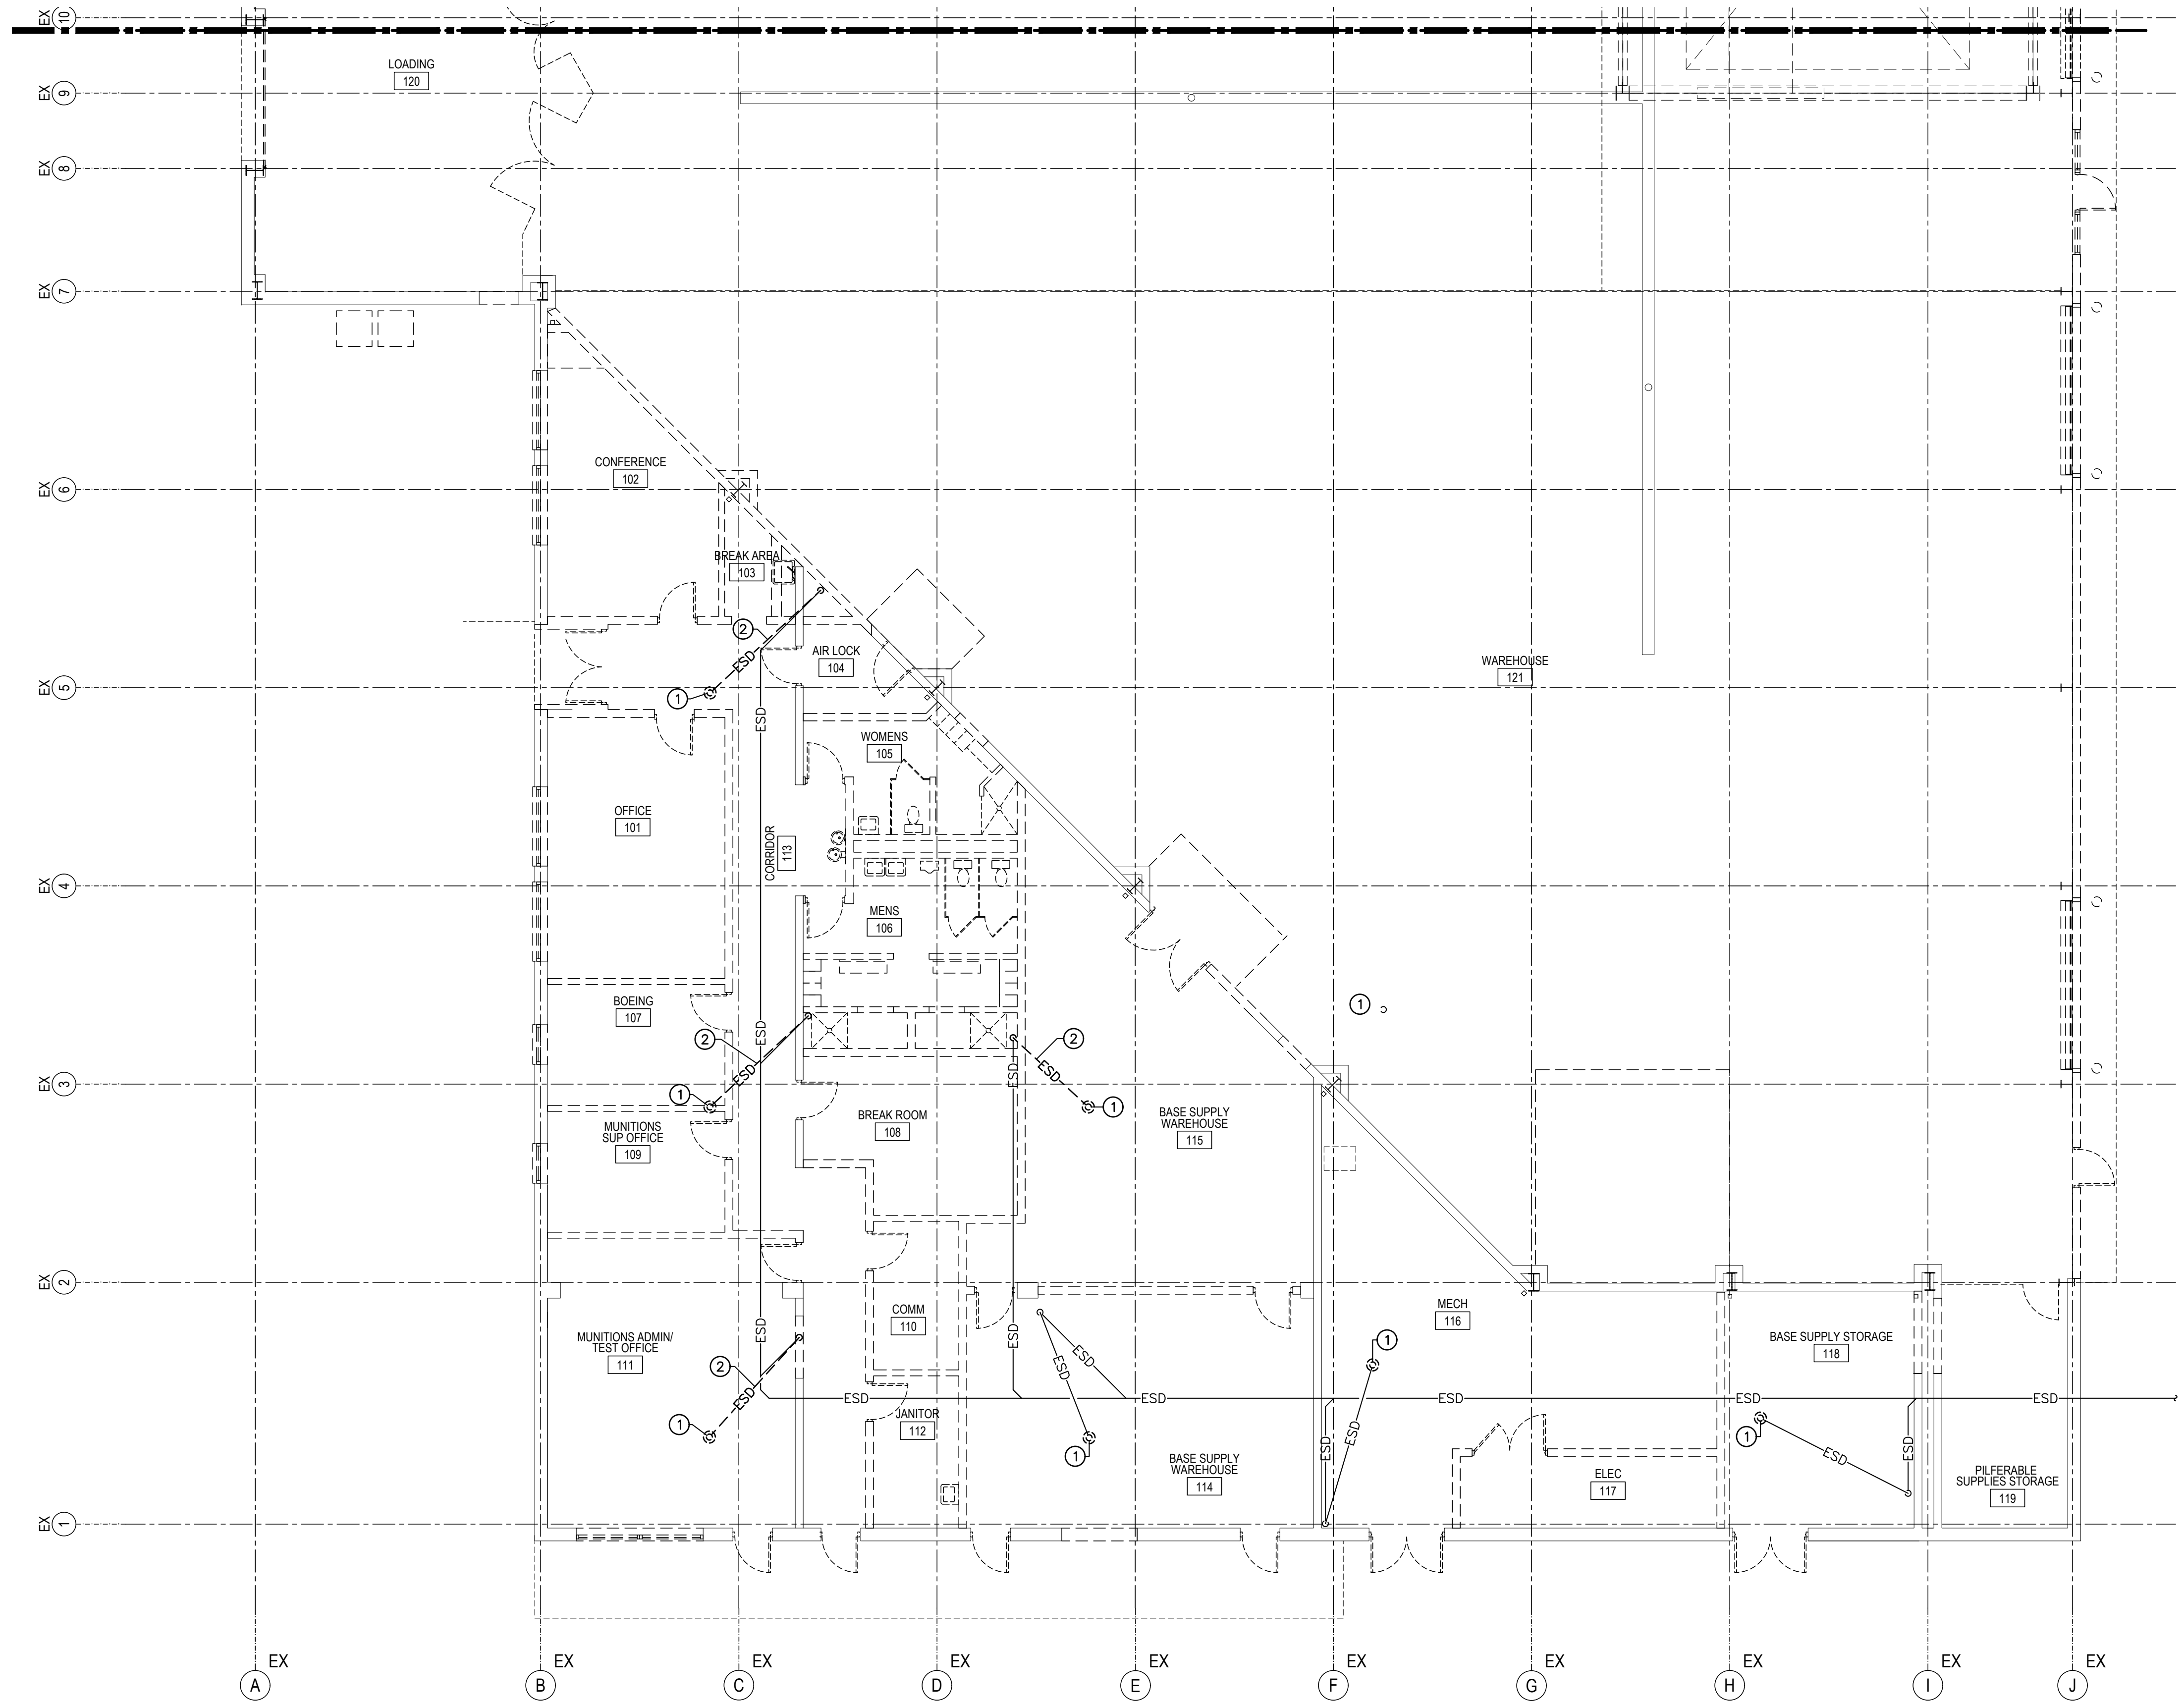


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PARTIAL FLOOR PLAN/
DOMESTIC WATER AND GAS DEMO.

SHEET NUMBER
P1.2

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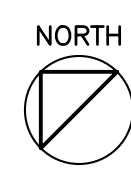
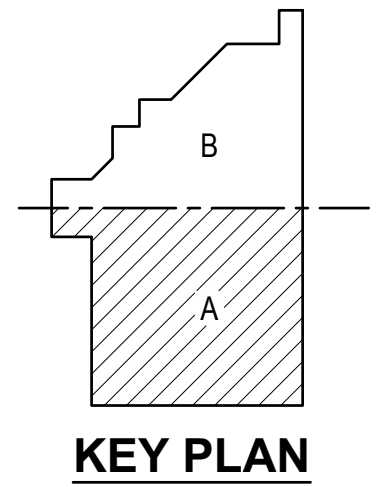


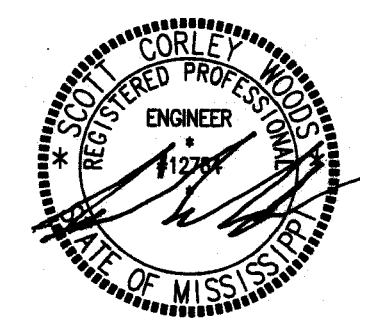KEYED DEMO. NOTES

- ① INDICATES EXISTING ROOF DRAIN TO BE REMOVED.
- ② INDICATES EXISTING 4" STORM DRAIN PIPING TO BE REMOVED FROM THE EXISTING ROOF DRAIN TO THE BELOW FLOOR. CAP THE EXISTING STORM DRAIN PIPING BELOW THE FLOOR AS REQUIRED.

GENERAL NOTES

- 1. FOR ALL NEW WORK AND PIPING SEE SHEET P2.4.
- 2. GENERAL CONTRACTOR SHALL PATCH THE EXISTING FLOOR AS DIRECTED BY THE ARCHITECT.




PARTIAL FLOOR PLAN-PART A/STORM DRAIN DEMOLITION

SCALE: 1/8"=1'-0"



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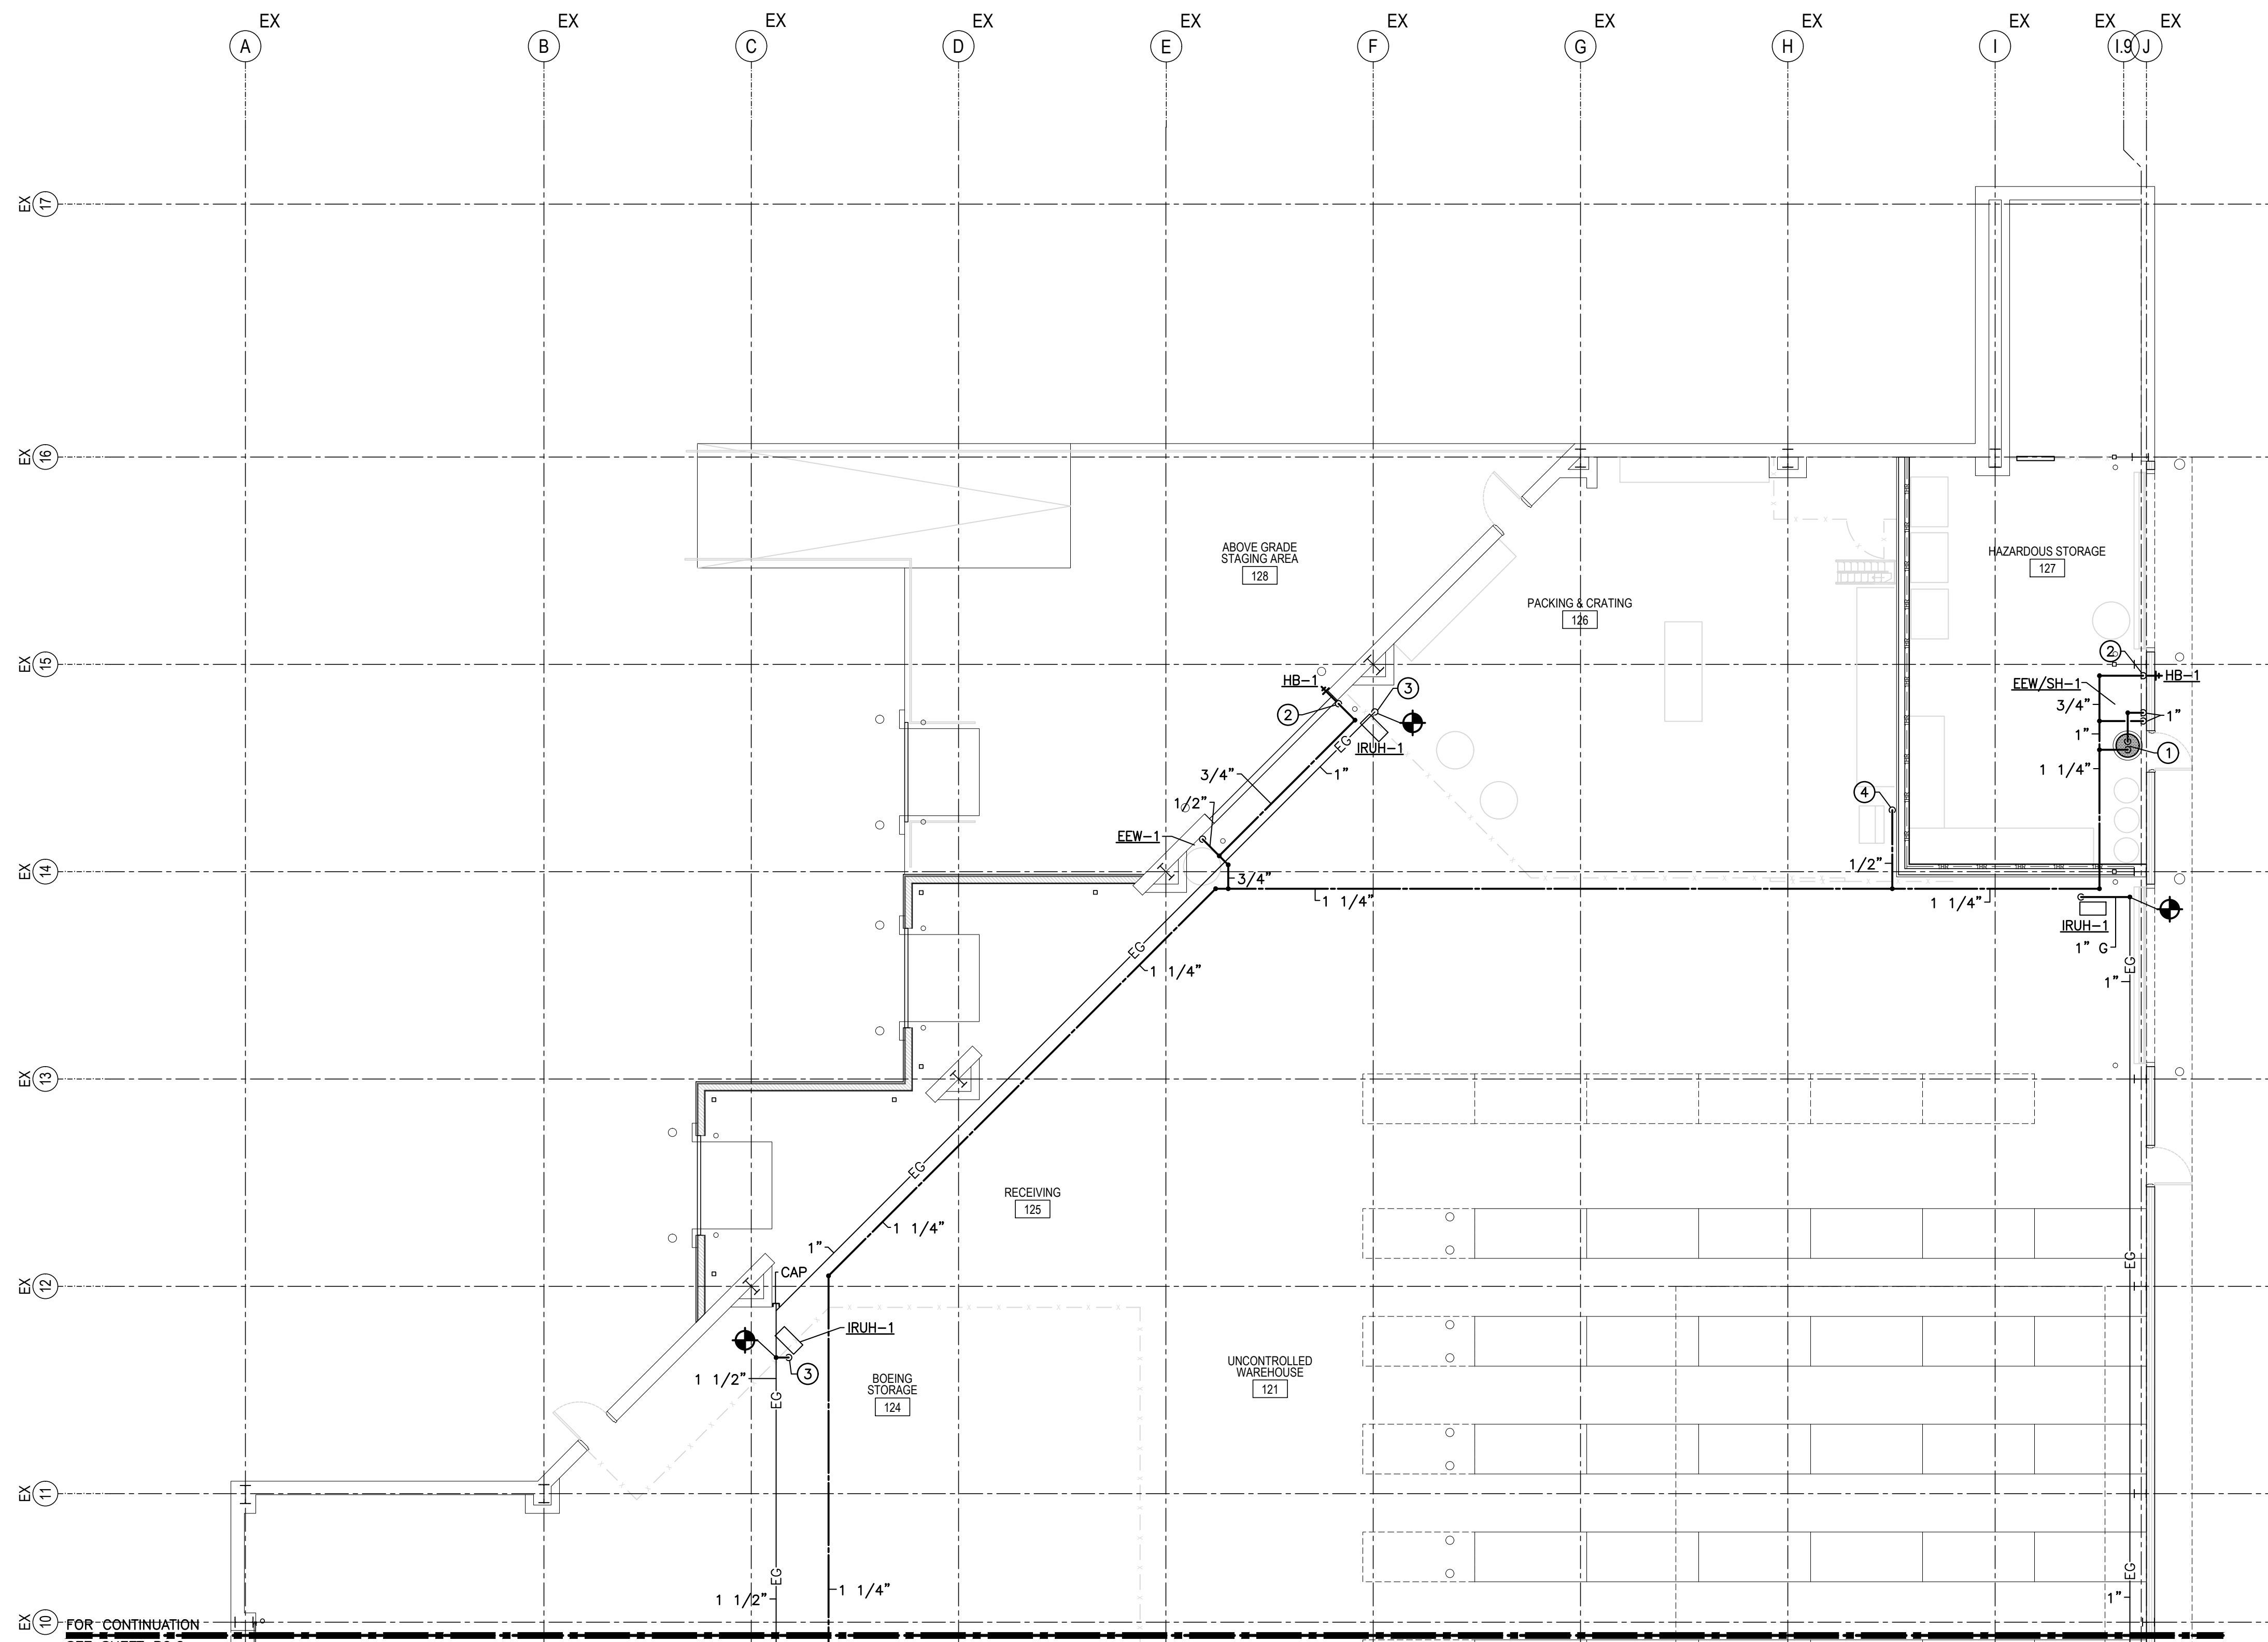


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PARTIAL FLOOR PLAN/
 STORM DRAIN DEMOLITION

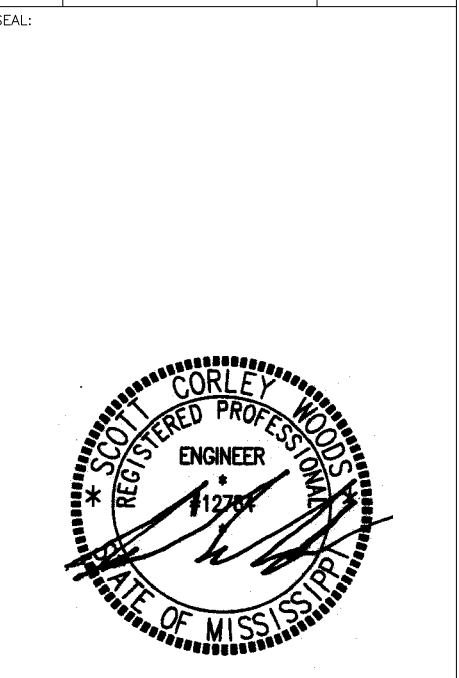P1.4

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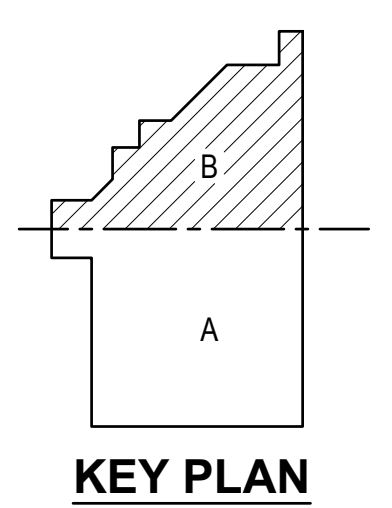


KEYED NOTES

- ① INDICATES 1" DOMESTIC COLD WATER LINE AND 1" DOMESTIC HOT WATER LINE DOWN TO WH-3 ON MEZZANINE FLOOR. SEE DETAIL.
- ② INDICATES BALL VALVE MOUNTED AT 8'-0" ABOVE THE FINISHED FLOOR IN THE DROP.
- ③ INDICATES 1" GAS LINE DOWN TO THE UNIT HEATER.
- ④ INDICATES 1/2" DOMESTIC COLD WATER LINE DOWN TO ICE MACHINE. PROVIDE BALL VALVE AT 3'-0" ABOVE THE FINISHED FLOOR AND MAKE FINAL CONNECTION TO THE ICE MACHINE WITH FLEXIBLE CONNECTOR AS REQUIRED.

GENERAL NOTES

- 1. ALL DOMESTIC WATER PIPING SHOWN SHALL BE RUN TIGHT TO THE ROOF TRUSSES UNLESS NOTED OTHERWISE.
- 2. CONTRACTOR SHALL PROVIDE A PDI-A ABOVE CEILING ON EACH DOMESTIC WATER LINE SERVING A SINGLE FIXTURE.
- 3. CONTRACTOR SHALL PROVIDE A GAS COCK, UNION, AND 6" DIRT LEG AT EACH GAS CONNECTION TO EQUIPMENT.
- 4. THIS CONTRACTOR SHALL FIELD VERIFY THE EXACT LOCATIONS AND SIZES OF ALL EXISTING UTILITIES BEFORE INSTALLING NEW PIPING.
- 5. THIS CONTRACTOR SHALL PROVIDE FIRE COLLARS ON ALL PVC PIPING THAT PENETRATES FIRE WALLS OR FLOORS AND FIRE CAULK AROUND ALL METAL PIPING THAT PENETRATES FIRE WALLS OR FLOORS. SEE ARCHITECTURAL PLANS FOR FIRE RATING.




PARTIAL FLOOR PLAN-PART B/DOMESTIC WATER AND GAS
 SCALE: 1/8"=1'-0"

FOR CONTINUATION
SEE SHEET P2.2




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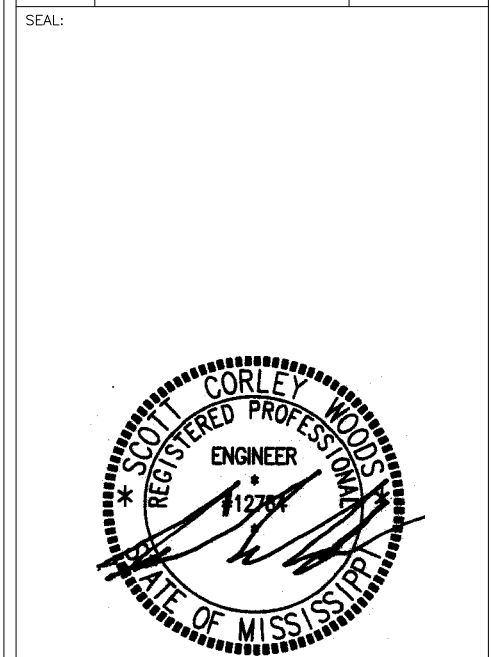
PARTIAL FLOOR PLAN/
DOMESTIC WATER AND GAS

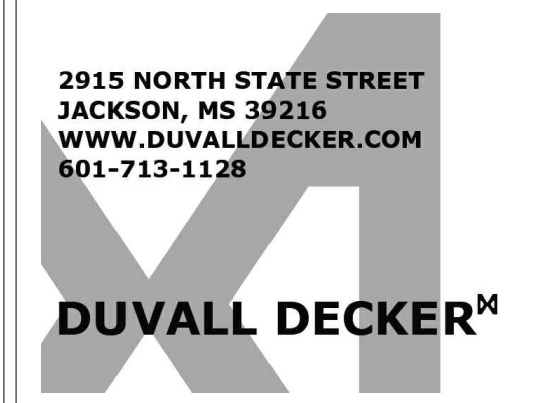SHEET NUMBER
P2.3

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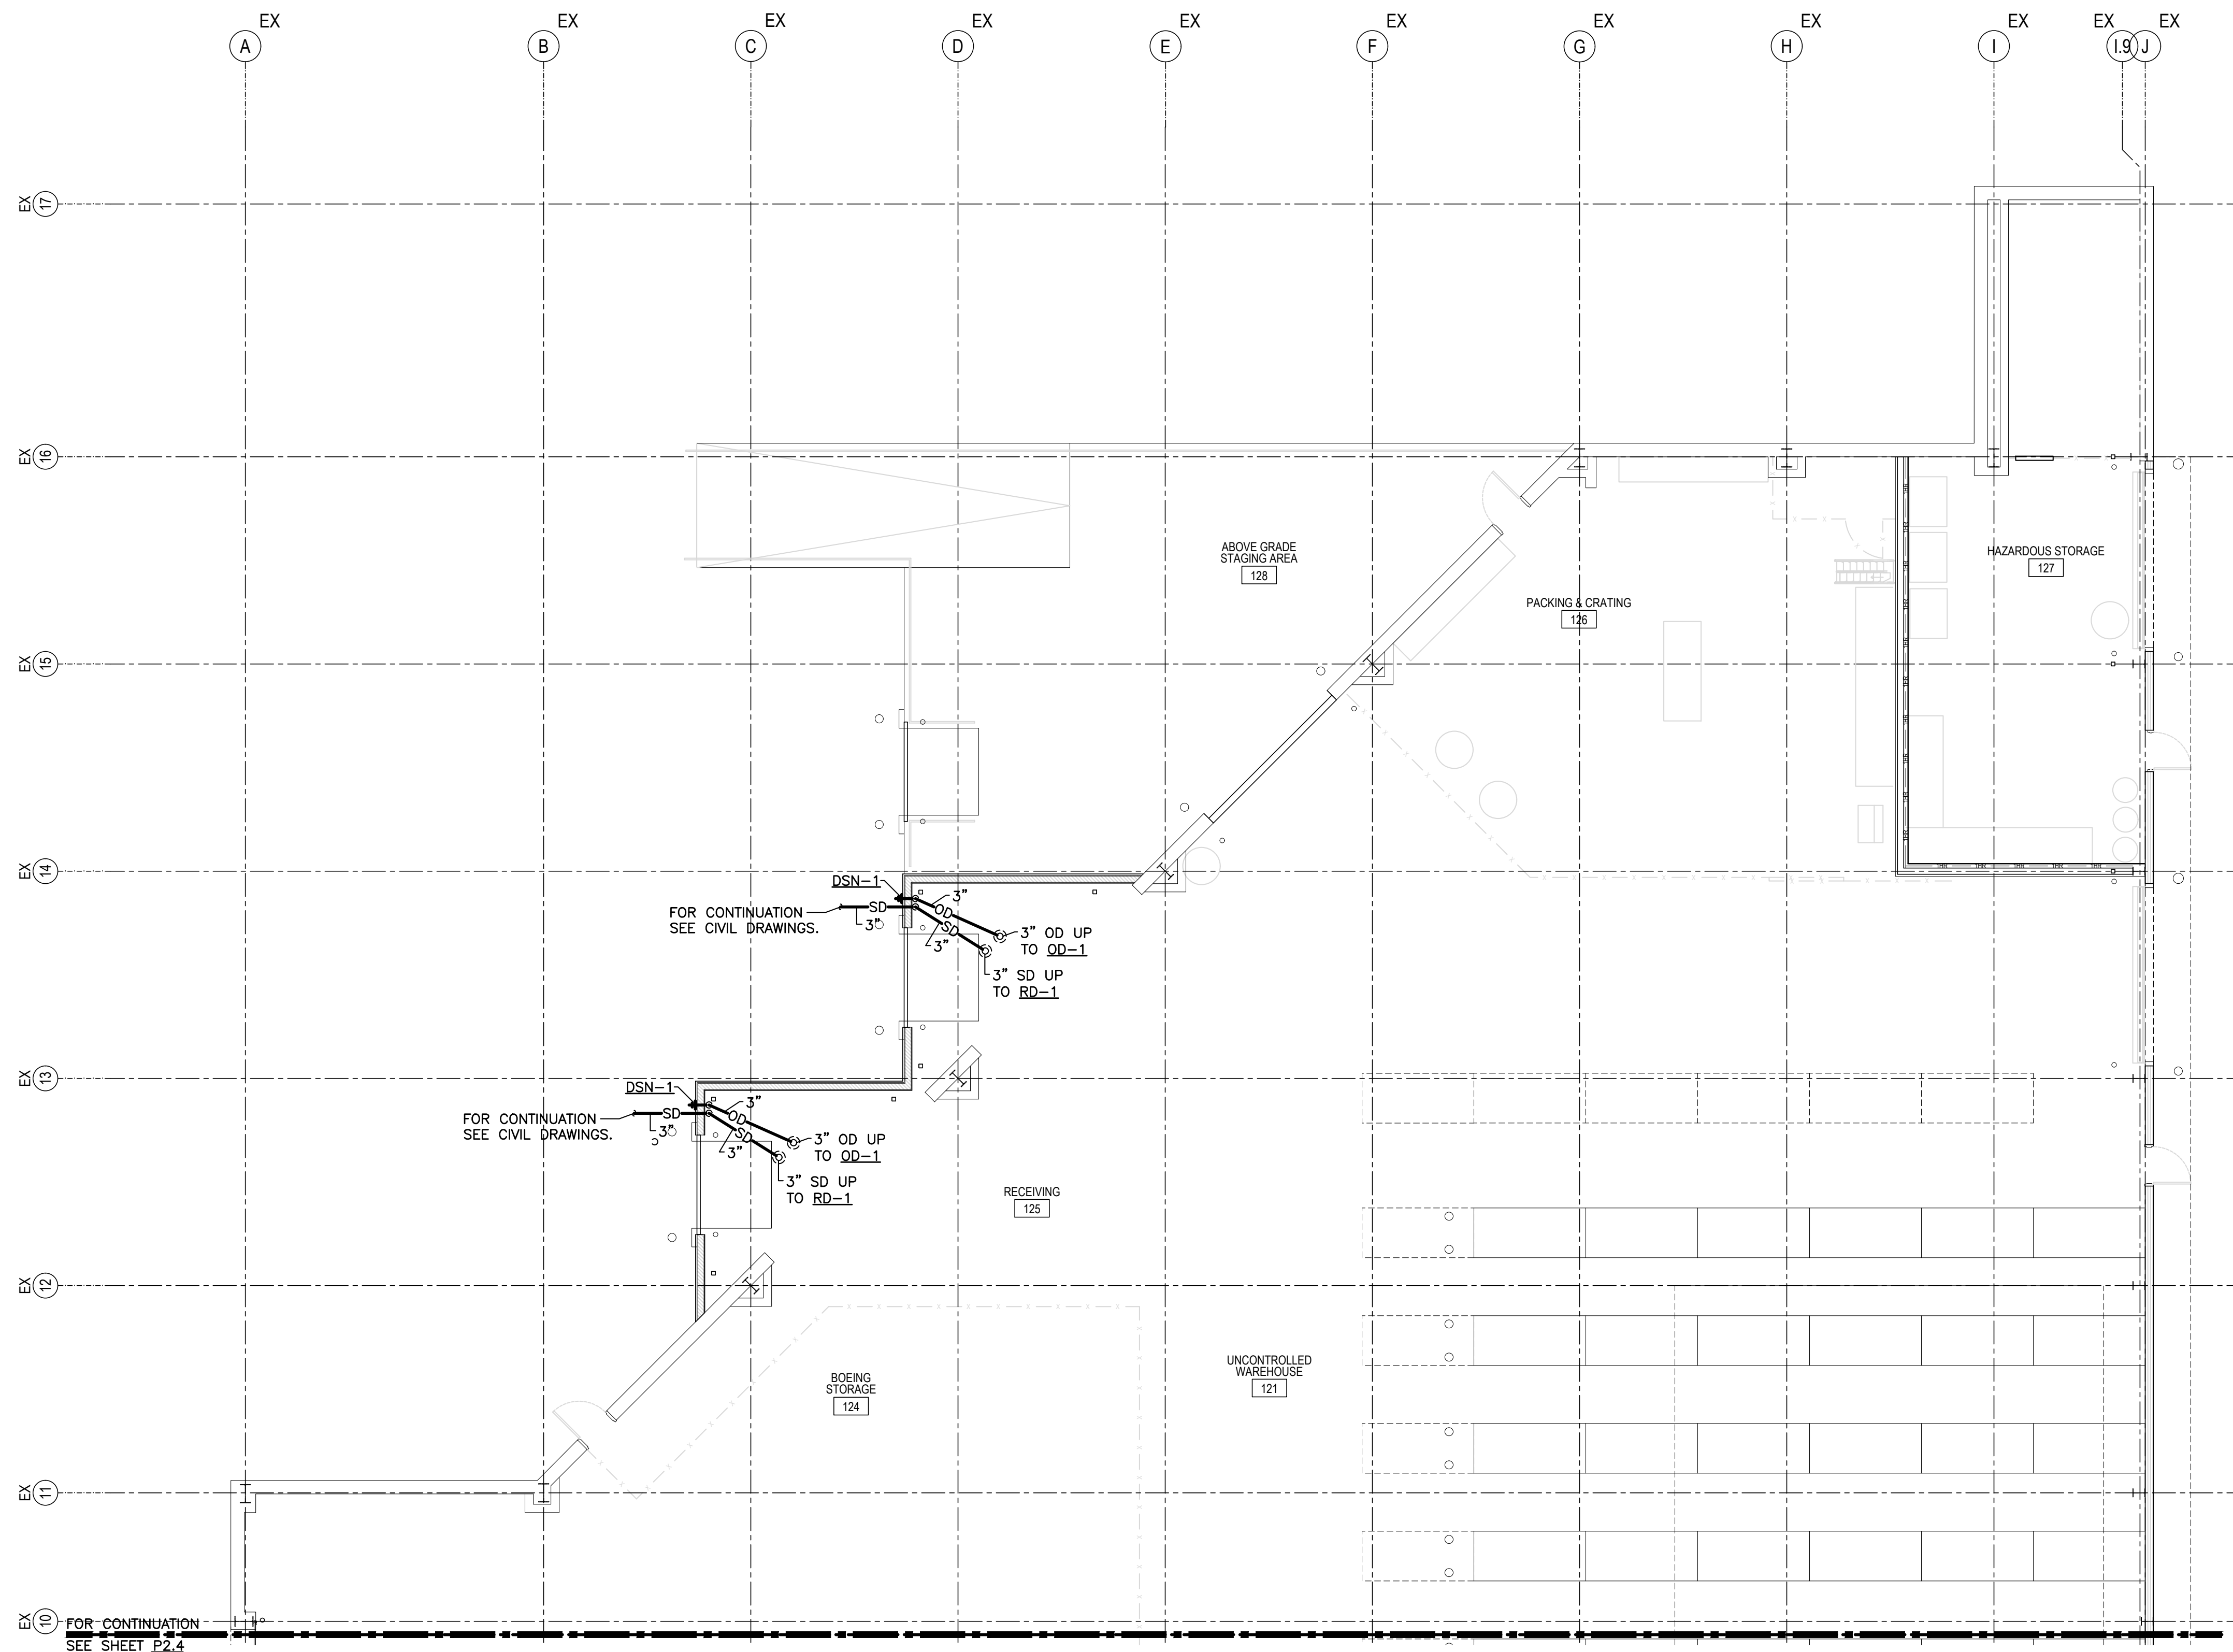
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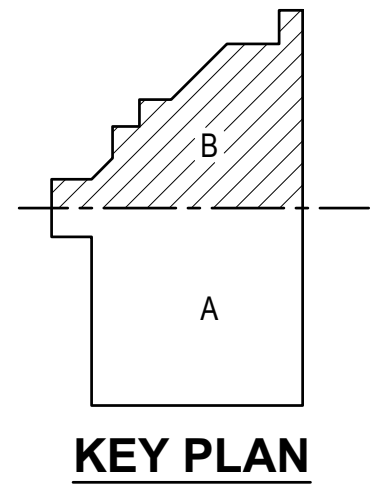
PARTIAL FLOOR PLAN/
 STORM DRAIN

SHEET NUMBER
P2.5

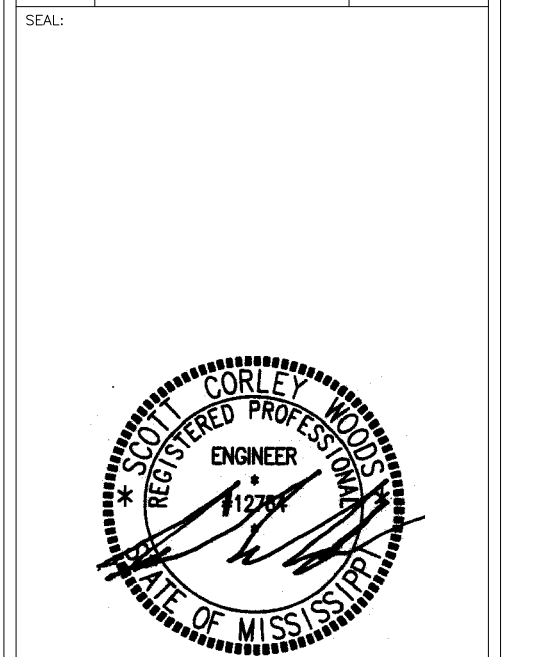

GENERAL NOTES

1. THIS CONTRACTOR SHALL COORDINATE STORM DRAIN PIPING INVERTS WITH CIVIL CONTRACTOR BEFORE INSTALLING PIPE.
2. ALL STORM DRAIN PIPING SHOWN SHALL BE RUN AS HIGH AS POSSIBLE AND SLOPED AT 1/8" PER FOOT MINIMUM UNLESS NOTED OTHERWISE.




PARTIAL FLOOR PLAN-PART B/STORM DRAIN
 SCALE: 1/8"=1'-0"
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FIRE SPRINKLER CLASSIFICATION (ESFR)

CODE - NFPA 13 (2019) AND UFC 3-600-01.
 OPEN RACK STORAGE UP TO 40'-0" IN HEIGHT.
 MAXIMUM 1,000 sqft. OF TIRE STORAGE.
 NFPA 13 SECTION 3.3.140 AND TABLE 23.5.1.
 PRESSURE AT HEAD - 40 psi.
 K-FACTOR - 22.4.
 REQUIRED FLOW - 1800 gpm PLUS 250 gpm HOSE STREAM.
 PUMP FLOW - 2,100 gpm.
 FIRE PUMP SHALL BE ELECTRIC. NO EMERGENCY POWER IS REQUIRED.

WATER TEST DATA

1. THE CONTRACTOR SHALL PERFORM A NEW FLOW TEST TO VERIFY AVAILABLE PRESSURE AND FLOW.
2. CURRENT TEST RESULTS AT ADJACENT FIRE HYDRANT ARE:
 STATIC PRESSURE - 70psi
 RESIDUAL PRESSURE - 62 psi AT 1,250 gpm

FIRE PROTECTION LEGEND

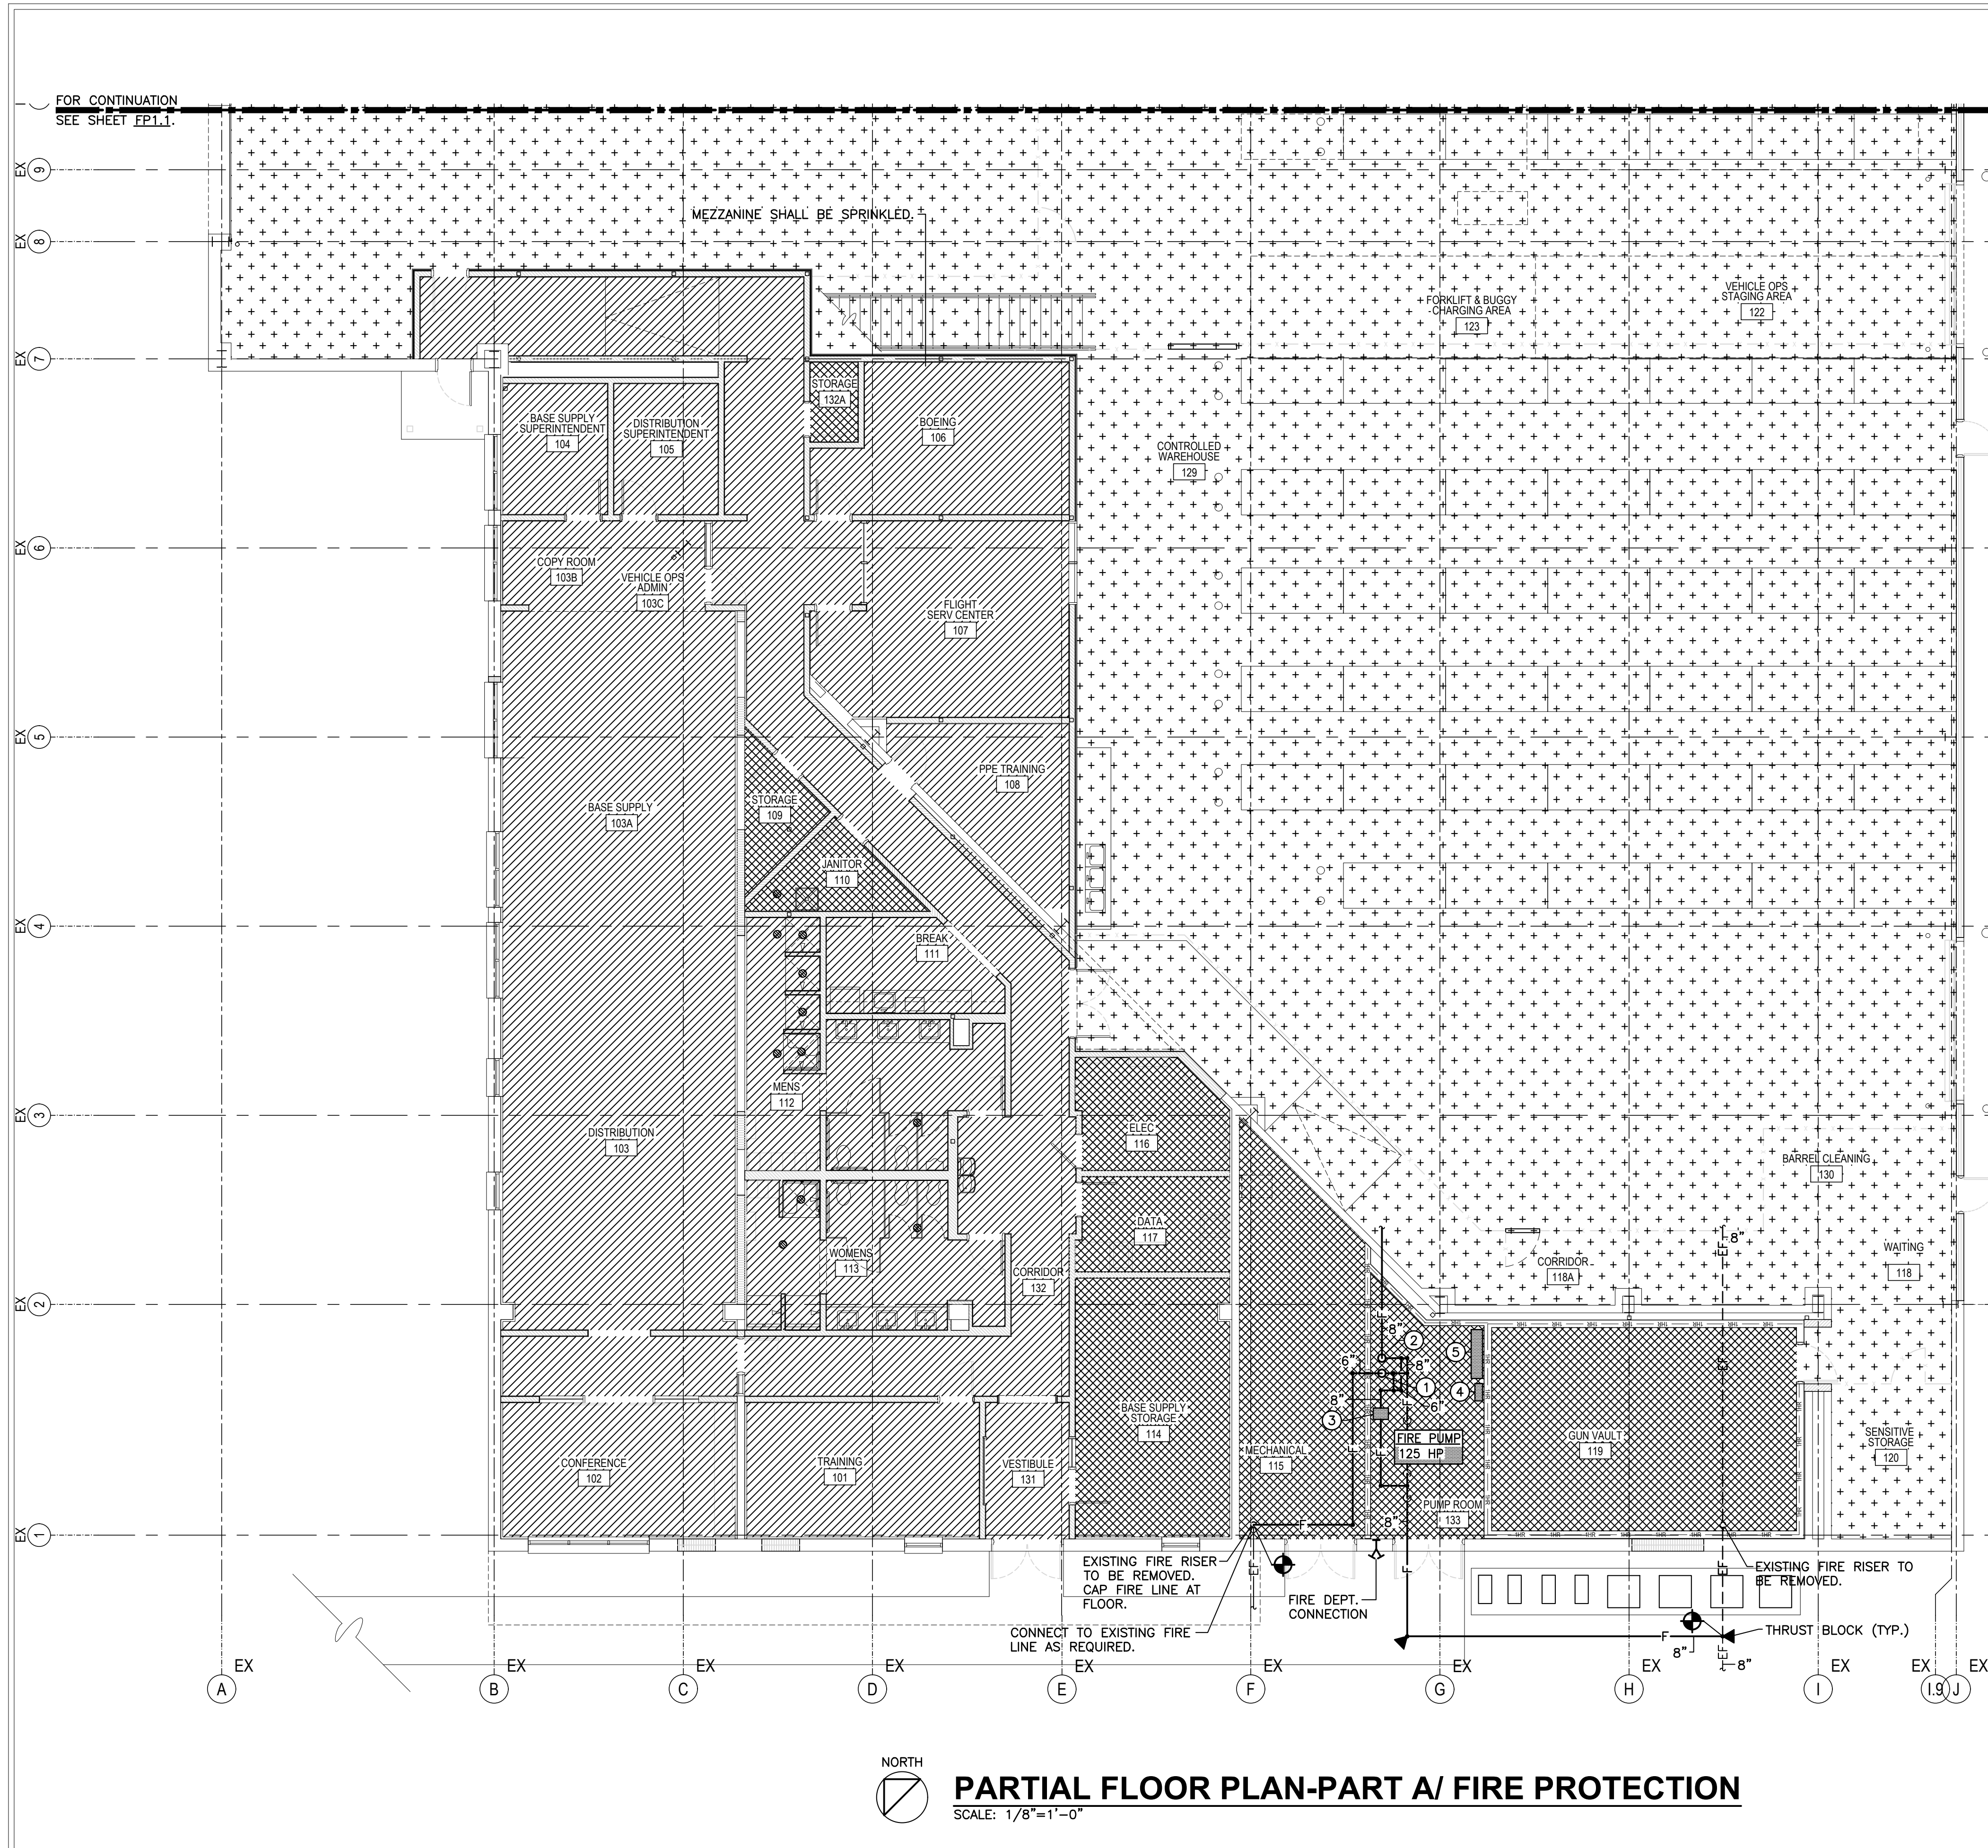
- LIGHT HAZARD
- ORDINARY HAZARD GROUP II
- ESFR

GENERAL FIRE PROTECTION NOTES

1. ALL SYSTEMS AND EQUIPMENT SHALL STRICTLY COMPLY WITH NFPA 13 AND UFC REQUIREMENTS.
2. CALCULATIONS AND SHOP DRAWINGS SHALL BE SUBMITTED TO ENGINEER AND ARCHITECT FOR APPROVAL BEFORE INSTALLING FIRE PROTECTION SYSTEM.
3. ALL FIRE PROTECTION WORK SHALL BE COORDINATED WITH OTHER TRADES TO AVOID CONFLICTS.
4. SPRINKLER HEADS SHALL BE INSTALLED IN CENTER OF CEILING TILES WHERE POSSIBLE.
5. SPRINKLER HEADS SHALL BE SEMI-RECESSED TYPE IN SPACES WITH CEILINGS. SPACES WITHOUT CEILINGS SHALL HAVE UPRIGHT HEADS.
6. CONTRACTOR SHALL VISIT SITE PRIOR TO BID DATE AND FIELD VERIFY EXACT LOCATION OF THE EXISTING FIRE MAIN.
7. CONTRACTOR SHALL PROVIDE OFFSETS OR MOVE ANY EXISTING SPRINKLER PIPE (AT NO ADDITIONAL COST TO THE OWNER) WHICH CONFLICTS WITH THE INSTALLATION OF THE NEW WORK THAT IS REQUIRED.
8. CONTRACTOR SHALL RELOCATE THE EXISTING SPRINKLER HEADS AS REQUIRED FOR THE NEW FLOOR PLAN TO CONFORM TO NFPA 13 AND UFC REQUIREMENTS.
9. FIRE PUMP, FLOW SWITCHES AND MONITORS SHALL COMMUNICATE WITH THE BASE FIRE ALARM SYSTEM.


KEYED NOTES

- ① INDICATES NEW 6" WET RISER.
- ② INDICATES NEW 8" ESFR RISER.
- ③ INDICATES JOCKEY PUMP.
- ④ INDICATES JOCKEY PUMP CONTROLLER.
- ⑤ INDICATES FIRE PUMP CONTROLLER.

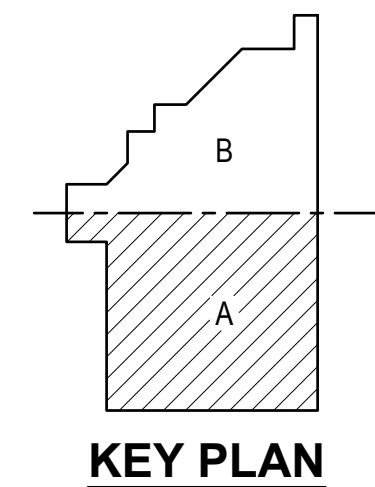

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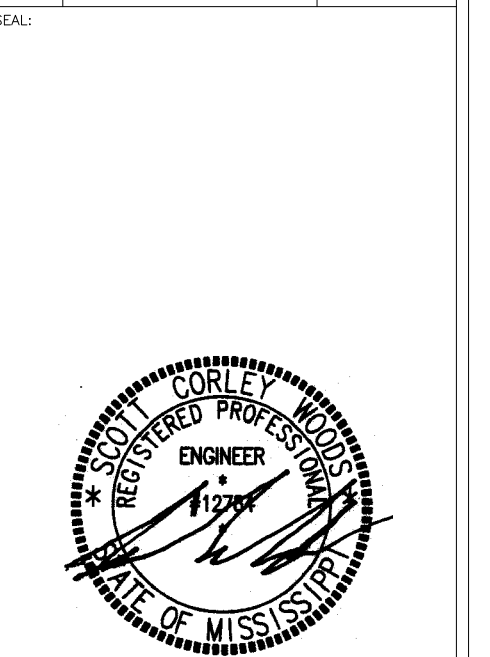


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DRAWING REVISIONS		
NO.	REMARKS	DATE

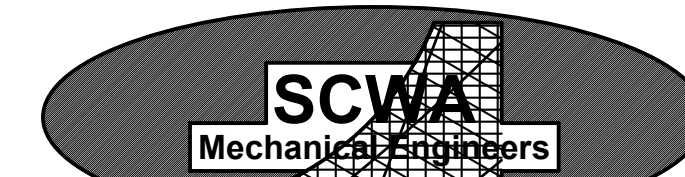


DRAWN BY: JOL	SCALE: NA
DESIGNED BY: JOL	DATE: OCTOBER 1, 2023
CHECKED BY: SCW	PROJECT: LRXQ172402
DRAWING TITLE:	

PARTIAL FLOOR PLAN/
 FIRE PROTECTION

SHEET NUMBER
FP1.0

N:\18052\Drawings\Plumbing\Phase 18052.dwg, 9/29/2023 10:10:25 AM, AutoCAD PDF (General Documentation).pc3

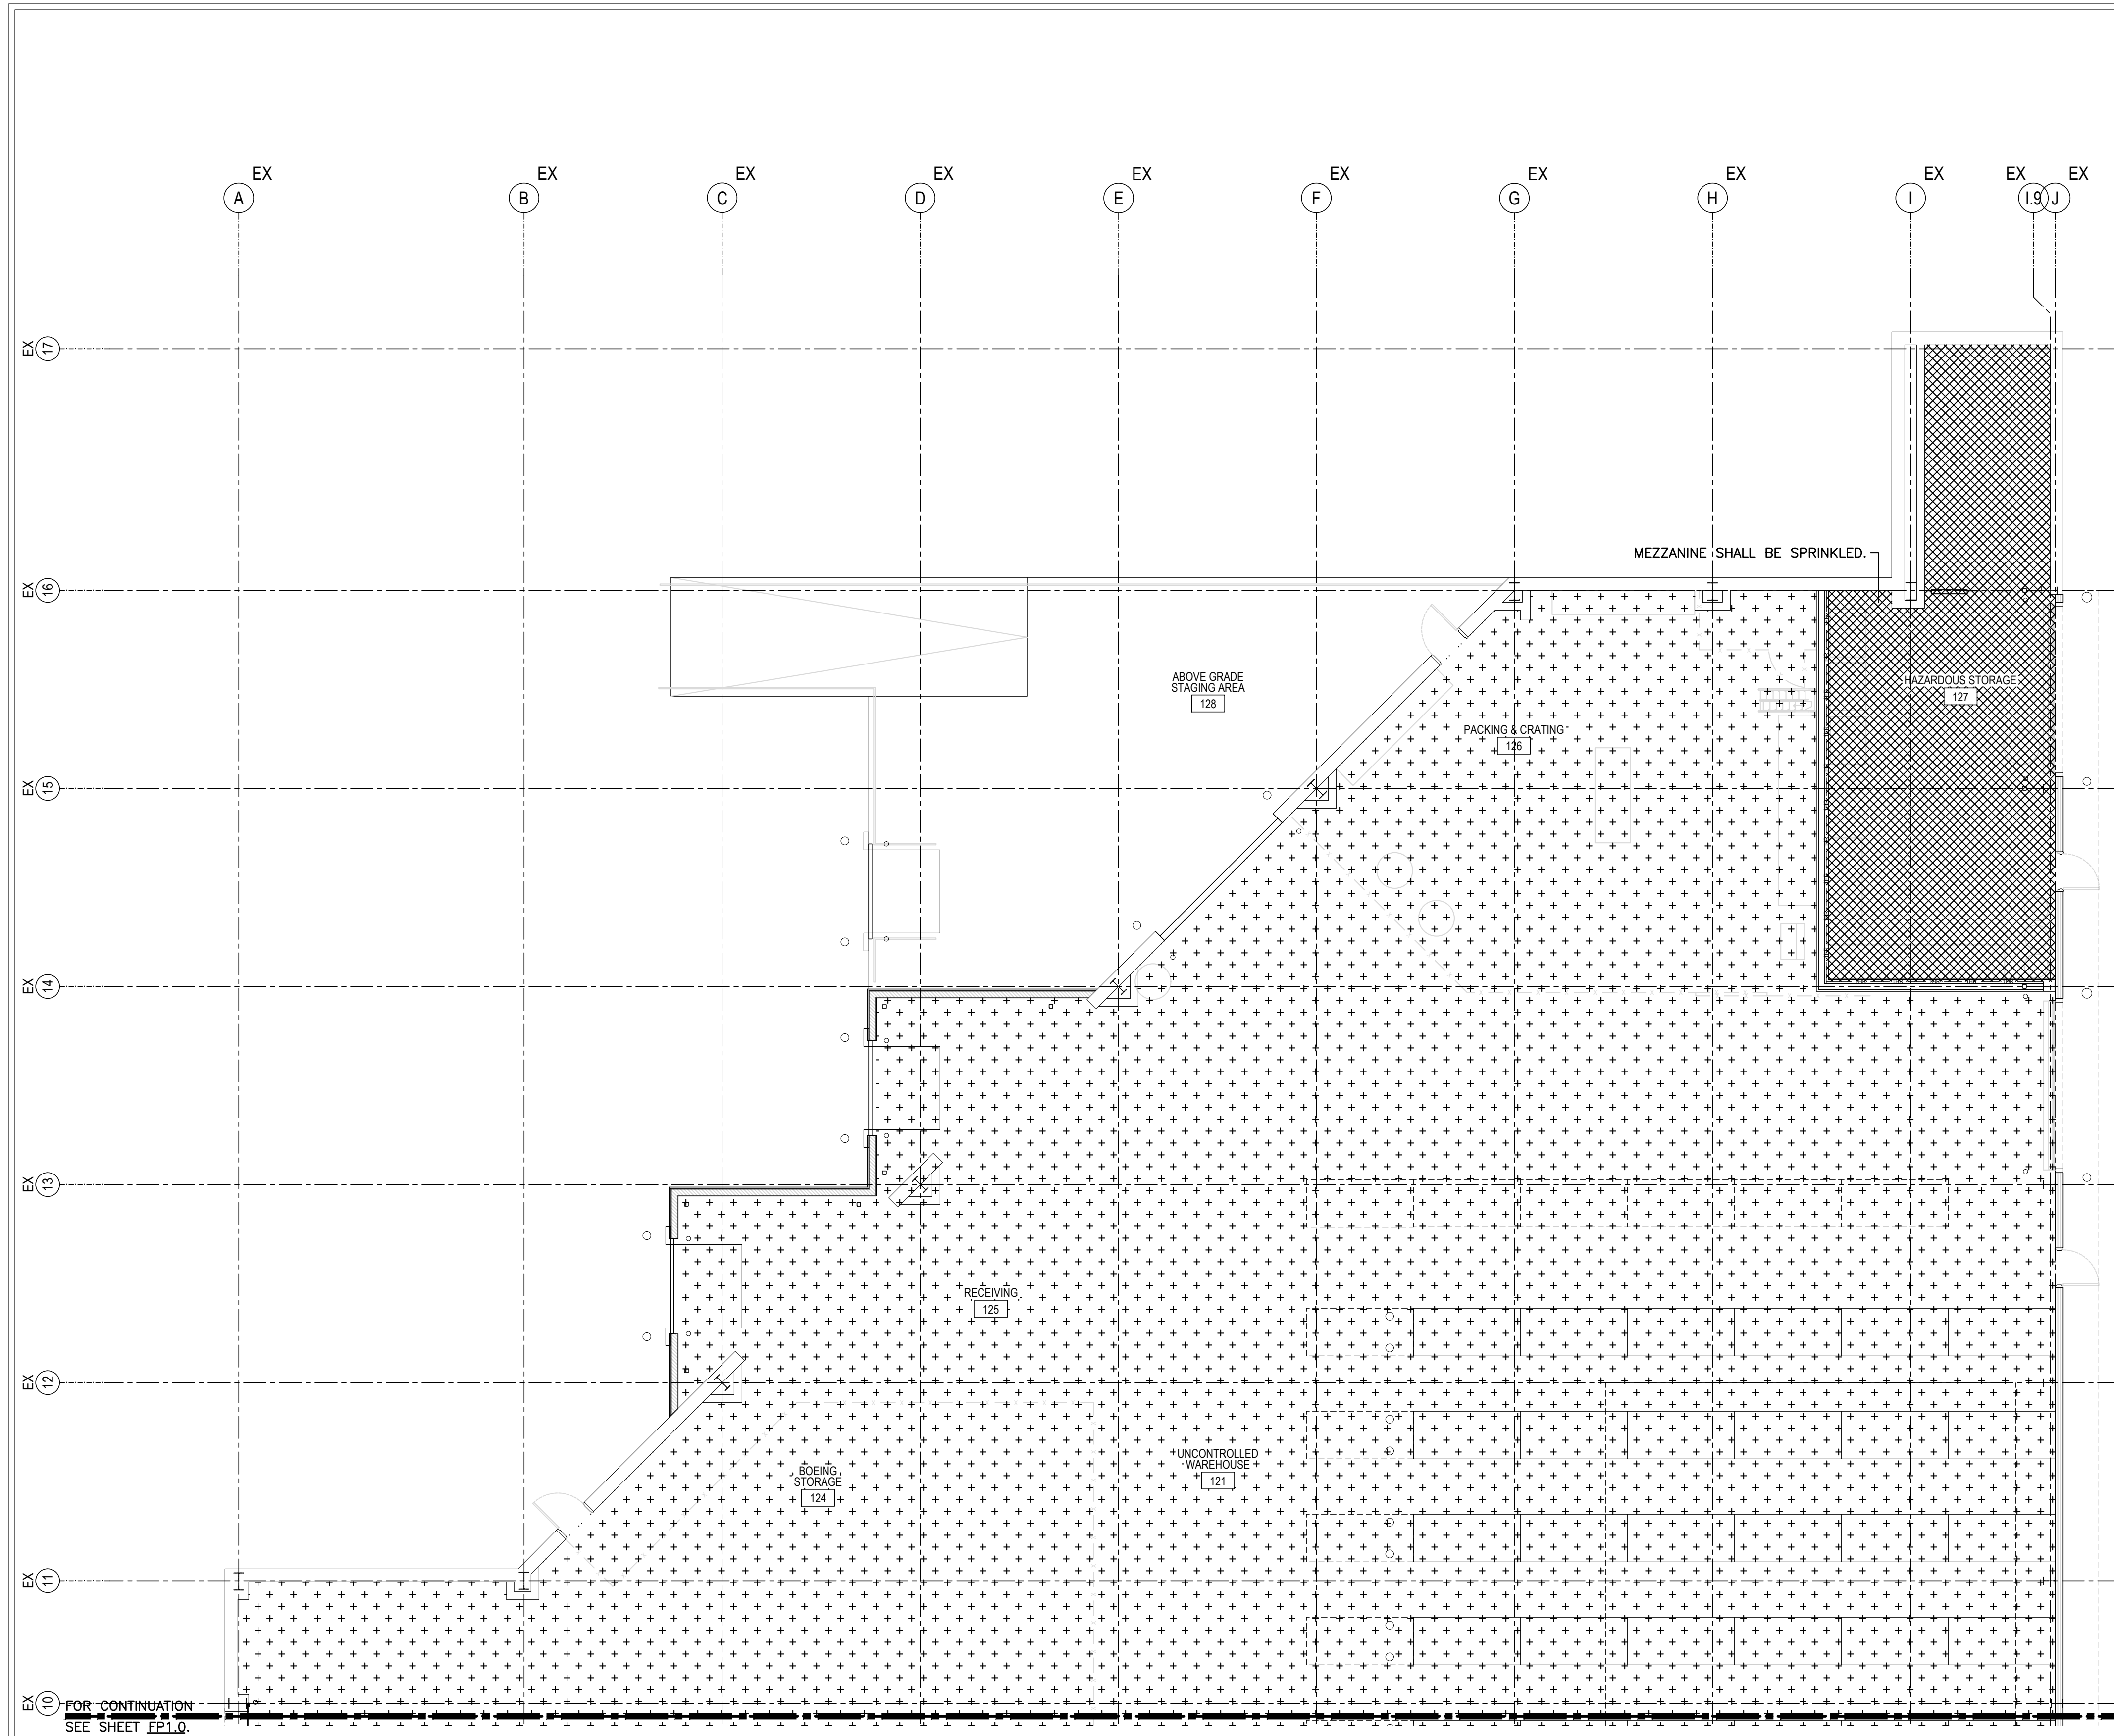

HAZARDOUS MATERIAL STORAGE CLASSIFICATIONS

REFERENCES:
 - UFC-4-440-1
 - UFC-4-440-1
 - UFC-4-440-1

STORED MATERIALS:
 - FLAMMABLE:
 - NONE
 - COMBUSTIBLE:
 - ALCOHOL BASED CLEANING SOLUTIONS (LIQUID)
 - PAINT
 - ACIDS:
 - HYDROCHLORIC ACID (LESS THAN 2 GALLONS)
 - SOLVENTS (LESS THAN 5 GALLONS)
 - OXIDIZERS:
 - BLEACH BASED CLEANERS (LIQUID)
 - NITRIC ACID BASE CLEANERS (LIQUID)
 - POISONS:
 - AMMONIA BASED PRODUCTS (LIQUID)


PER NFPA 400 TABLE 5.2.1.1.3:
 - QUANTITIES OF STORED MATERIALS ARE BELOW THE MAXIMUM ALLOWABLE AMOUNTS BY WEIGHT AND VOLUME TO REQUIRE CHEMICAL FIRE SUPPRESSION SYSTEMS.
 - HAZARDOUS STORAGE MAKES UP LESS THAN 5% OF THE BUILDING FLOOR SPACE.
 - ACIDS ARE STORED IN APPROVED HAZARDOUS MATERIALS STORAGE CABINETS.
 - HAZARDOUS STORAGE IS VENTILATED PER NFPA 30 SECTION 9 AND 18.6.
 - STORAGE HEIGHTS ARE LESS THAN 12' INSIDE A RATED ENCLOSURE.
 - SPACE SHALL INCLUDE A WET PIPE SPRINKLER SYSTEM CLASSIFIED AS ORDINARY HAZARD GROUP II.

FIRE SPRINKLER CLASSIFICATION (ESFR)

CODE - NFPA 13 (2019) AND UFC 3-600-01.
 OPEN RACK STORAGE UP TO 40'-0" IN HEIGHT.
 MAXIMUM 1,000 sqft. OF TIRE STORAGE.
 NFPA 13 SECTION 3.3.140 AND TABLE 23.5.1.
 PRESSURE AT HEAD - 40 psi.
 K-FACTOR - 22.4.
 REQUIRED FLOW - 1800 gpm PLUS 250 gpm HOSE STREAM.
 PUMP FLOW - 2,100 gpm.
 FIRE PUMP SHALL BE ELECTRIC. NO EMERGENCY POWER IS REQUIRED.

FIRE PROTECTION LEGEND

- LIGHT HAZARD
- ORDINARY HAZARD GROUP II
- ESFR

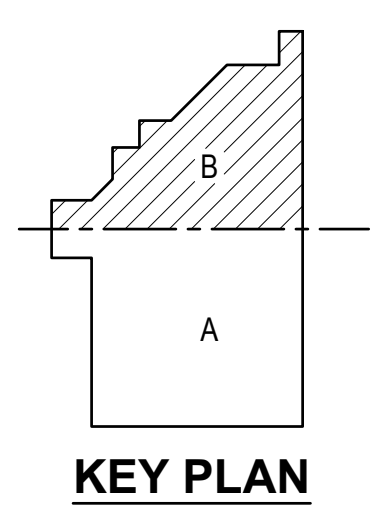


PARTIAL FLOOR PLAN-PART B / FIRE PROTECTION
 SCALE: 1/8"=1'-0"



FOR CONTINUATION
 SEE SHEET FP1.0




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 1-800-661-3733

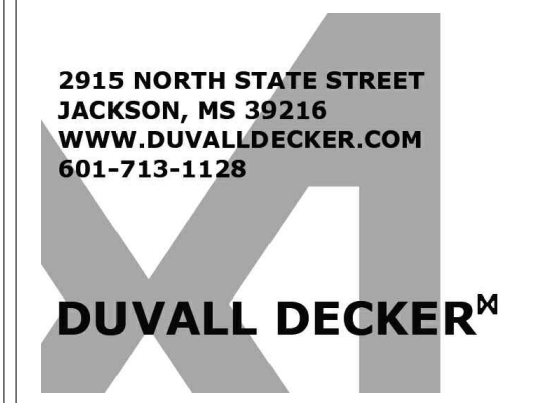

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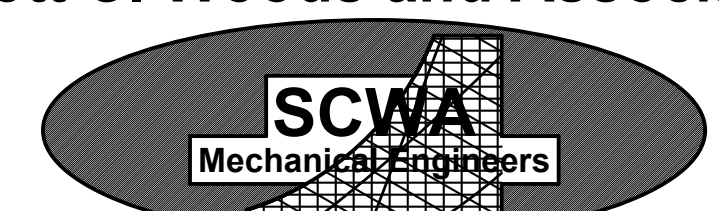
**RENOVATE BASE SUPPLY
 WAREHOUSE B180**
 MS AIR NATIONAL GUARD
 172ND AIRLIFT WING
 PROJECT# LRXQ 172402

DRAWING REVISIONS		
NO.	REMARKS	DATE

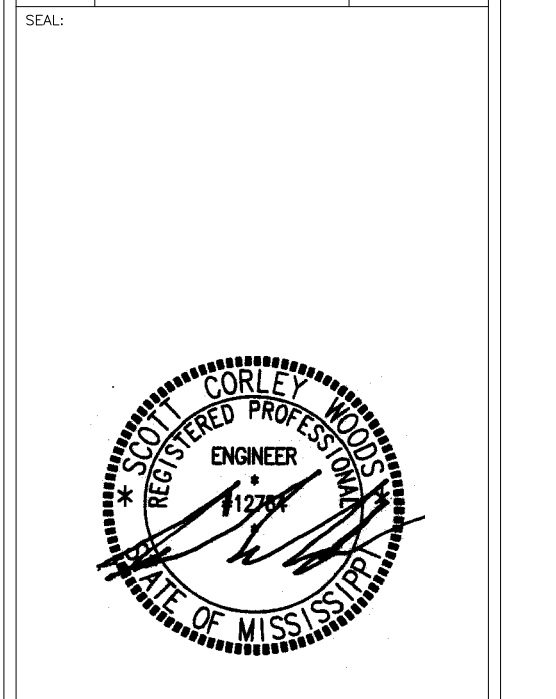

DRAWN BY: JOL	SCALE: NA
DESIGNED BY: JOL	DATE: OCTOBER 1, 2023
CHECKED BY: SICW	PROJECT: LRXQ172402
DRAWING TITLE	

SCWA #18-052
Scott C. Woods and Associates



112 Lone Wolf Dr./Madison, Ms 39110
 Ph. (601)859-9864/Fax (601)859-2564/Email www.scweng.com

PARTIAL FLOOR PLAN/
 FIRE PROTECTION

SHEET NUMBER
FP1.1

PANEL 'MDP' SCHEDULE												
LOCATION:		ELEC ROOM	RATING:	800A	AIC:	20K	ENCLOSURE: NEMA 1					
VOLTAGE:		277/480V	TYPE:	MCB								
WIRING:		30/4W										
CKT	BKR	DESCRIPTION	CLASS	LOAD	A	B	C	LOAD	CLASS	DESCRIPTION	BKR	CKT
1	20A/1P	HEI VIA MTS-1	R	0.786	8568	11550		7014	1		HI 125A/3P	2
2	20A/1P	SPARE	N	0	0	0	0	0	N	SPACE		3
3	20A/1P	SPD	N	0	5040		5040	0.799	N	SPARE 20A/1P	6	4
4	20A/1P	SPD	N	0	5040		5040	0.799	N	SPARE 20A/1P	6	5
5	20A/1P	SPD	N	0	5040		5040	0.799	N	SPARE 20A/1P	6	6
6	20A/1P	SPD	N	0	5040		5040	0.799	N	SPARE 20A/1P	6	7
7	20A/1P	SPD	N	0	5040		5040	0.799	N	SPARE 20A/1P	6	8
8	20A/1P	SPD	N	0	5040		5040	0.799	N	SPARE 20A/1P	6	9
9	20A/1P	SPD	N	0	5040		5040	0.799	N	SPARE 20A/1P	6	10
10	20A/1P	SPD	N	0	5040		5040	0.799	N	SPARE 20A/1P	6	11
11	20A/1P	SPD	N	0	5040		5040	0.799	N	SPARE 20A/1P	6	12
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DEMAND FACTORS		C. LOAD	DEMAND	D. LOAD	LOAD SUMMARY
LIGHTING	L	0	100%	0	CONNECTED: 161072 VA : 194 A
RECEPTACLE	R				

